# Architectural Review Town of Ossining

#### Presented by: Brian Contreras & Stephanie Diesing

#### For:

68A Somerstown Road, Ossining, NY 10562 (Lot 2) S/B/L # 90.10 3 3.2

#### Roof Shingles:

- Manufacturer/Product: CertainTeed Landmark Pro Series
- Color: Max Def Weathered Wood

#### Siding:

- Manufacturer Product: LP SmartSide Lap Siding
- Prefinisher: Diamond Kote
- Color: Custom Dark Navy Blue. Printed color is not an exact representation.

#### Stone:

- Manufacturer/Product: Boral Versetta Stone Tight-Cut
- Color: Sand

#### Windows:

- Manufacturer: Paradigm or Andersen Vinyl
- Color: White

#### Front Door:

 Manufacturer/Product: Therma-Tru – Classic-Craft® Rustic Collection™ 2 Panel Soft Arch | Style No. CCR200

#### Garage Side Door:

Manufacturer/Product: Therma-Tru – Fiber-Classic® Mahogany Collection™ Half Lite 1 Panel
 Style No. FCM6022XC-SDL

#### Garage Door:

- Manufacturer/Product: Wayne Dalton Carriage House Steel 6600 Panel 16' x 7'
- Color: White



NOTES:

1) ALL WINDOW SIZES CALLED OUT ON FLOOR PLANS ARE "ANDERSEN UNIT NUMBERS", IF "ANDERSEN" WINDOWS ARE NOT USED, A WINDOW OF EQUAL TYPE AND UNIT DIMENSION IS TO BE USED 2) ALL GLAZING TO BE DOUBLE INSULATED 3) ALL GLAZING TO BE "HIGH PERFORMANCE", "LOW-E" GLASS 4) ALL GLAZING WITHIN 18" OF FINISHED FLOOR TO BE TEMPERED

ALL OPERABLE WINDOWS THAT HAVE
A SILL HEIGHT OF LESS THAN 24"
ABOVE THE FINISHED FLOOR AND
MORE THAN 72" ABOVE FINISHED
GRADE MUST BE PROVIDED WITH
WINDOW FALL PREVENTION DEVICES
THAT COMPLY WITH ASTM F 2090

CONTRACTOR TO AFFIX AN APPROVED SIGN/SYMBOL TO THE EXTERIOR ELECTRIC BOX AT THE SERVICE POINT. THE SIGN IS TO INDICATE THE USE OF TRUSSES, PRE—ENGINEERED WOOD GIRDERS, BEAMS OR JOISTS THAT ARE BONDED WITH ADHESIVES (INCLUDING I—JOISTS, STRUCTURAL GLUED LAMINATED TIMBERS, STRUCTURAL LOG MEMBERS, STRUCTURAL COMPOSITE LUMBER & CROSS—LAMINATED TIMBER) AND/OR TIMBER CONSTRUCTION

SQUARE	FOOTAGE:
1st FLOOR:	1106
2nd FLOOR:	1127
TOTAL:	2233
GARAGE:	610
BONUS ROOM	M: 317

EGRESS REQUIREMENTS

WINDOW	SQ.FT. CLEAR	WIDTH CLEAR	HEIGH CLEAR		
3049	5.7	32.56"	25.20		



FRONT ELEVATION

SCALE: 1/4" = 1'-0"

RIGHT SIDE ELEVATION

SCALE: 1/4" = 1'-0"

RAILING & STAIR NOTES:

STAIRS WITH (4) OR MORE RISERS SHALL BE PROVIDED WITH HANDRAILS ON AT LEAST ONE SIDE. HANDRAILS SHALL BE A MINIMUM OF 34" IN HEIGHT AND NOT MORE THAN 38" IN HEIGHT. RAILS ARE TO BE MEASURED VERTICALLY FROM THE NOSING OF THE TREADS. CIRCULAR HANDRAILS SHALL HAVE AN OUTSIDE DIAMETER OF AT LEAST 1 1/4" AND NOT GREATER THAT 2". IF THE HANDRAIL IS NOT CIRCULAR IT SHALL HAVE A PERIMETER OF AT LEAST 4" AND NOT MORE THAN 6 1/4".

PORCHES, DECKS, BALCONIES OR RAISED FLOOR SURFACES LOCATED MORE THAN 30" ABOVE THE FLOOR OR GRADE BELOW SHALL HAVE GUARDS A MINIMUM OF 36" HIGH.

RISERS ARE TO BE CLOSED SUCH THAT THE OPENING BETWEEN THE TREADS DOES NOT PERMIT THE PASSAGE OF A 4" DIAMETER SPHERE.

TABLE R301.2(1) CLIMATE AND GEOGRAPHIC DESIGN CRITERIA													
GROUND SNOW	WIND DESIGN TOPOGRAPHIC SPECIAL WIND WIND-BORNE				SEISMIC SUBJECT TO DAMAGE FROM DESIGN FROST LINE			WINTER DESIGN	ICE BARRIER UNDERLYMT	FLOOD	AIR FREEZING	MEAN ANNIJAI	
LOAD	SPEED (mph)	EFFECTS	REGION	DEBRIS ZONE	CATEGORY	WEATHERING	DEPTH	TERMITE	TEMP	REQUIRED	HAZARDS	INDEX	TEMP
30	115 MPH	NO	YES	NO	В	SEVERE	42"	MODHEAVY	-1	YES	MAY 2, 2012	1500	47.4

NEW RESIDENCE FOR: Stephanie Diesing & Brian Contreras **NEW YORK** 

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SOMERSTOWN ROAD,

68A



SEPTEMBER 13, 2017 OCTOBER 9, 2017

NYSPE #074666


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TOP PLATE,

WINDOW HDR.

SECOND FLOOR,

FIRST FLOOR

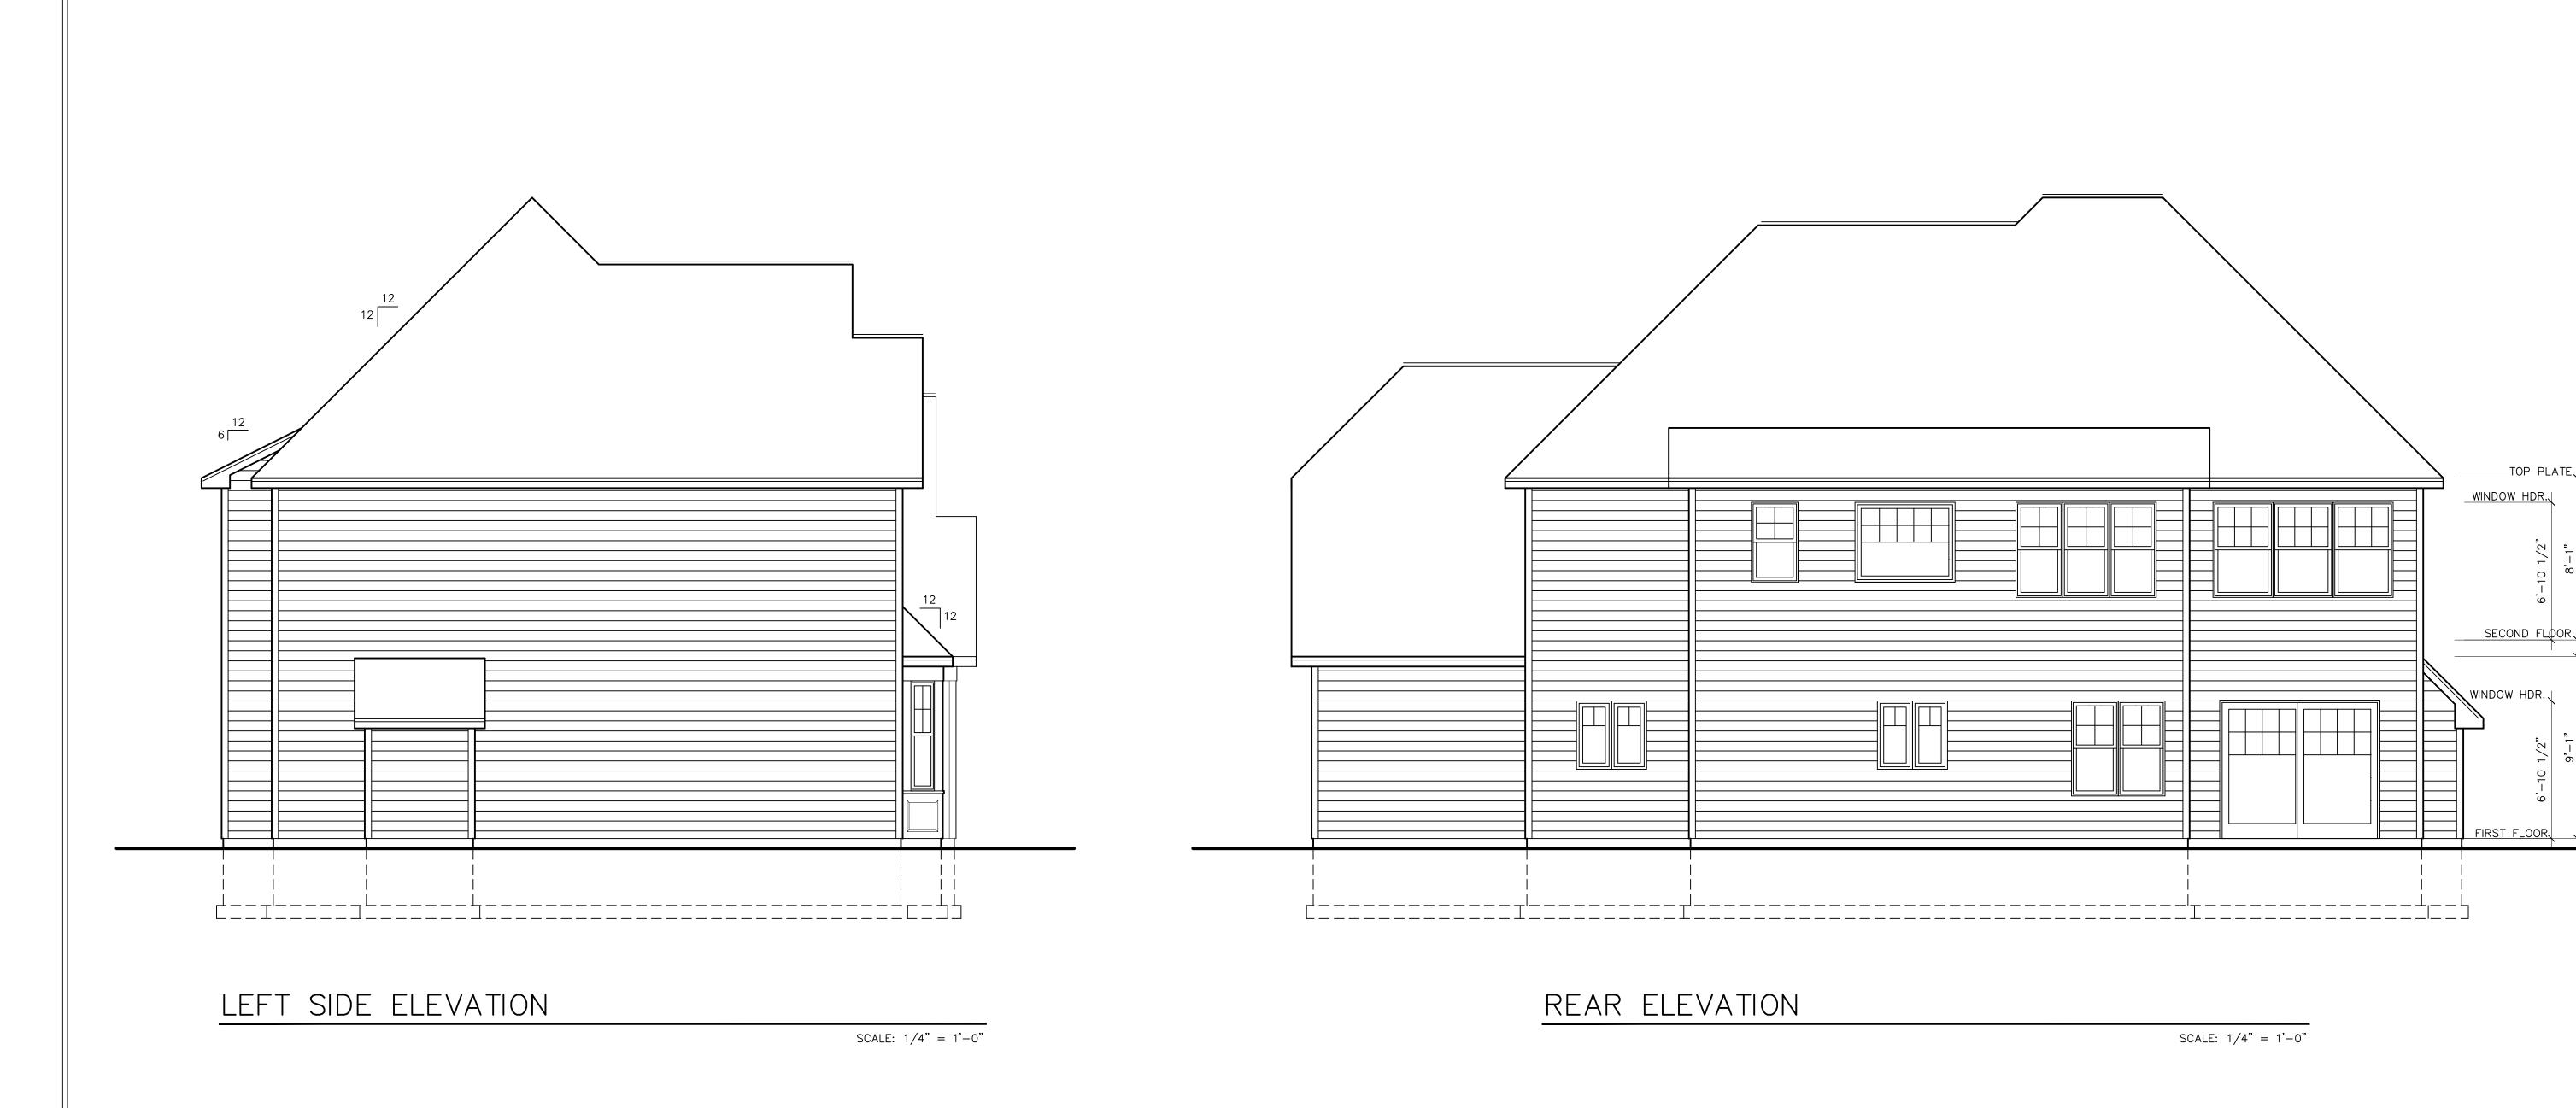

RAILING & STAIR NOTES:

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4" DIAMETER SPHERE.

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Stephanie Diesing & Brian Contreras
68A SOMERSTOWN ROAD, TOWN OF OSSINING, NEW YORK

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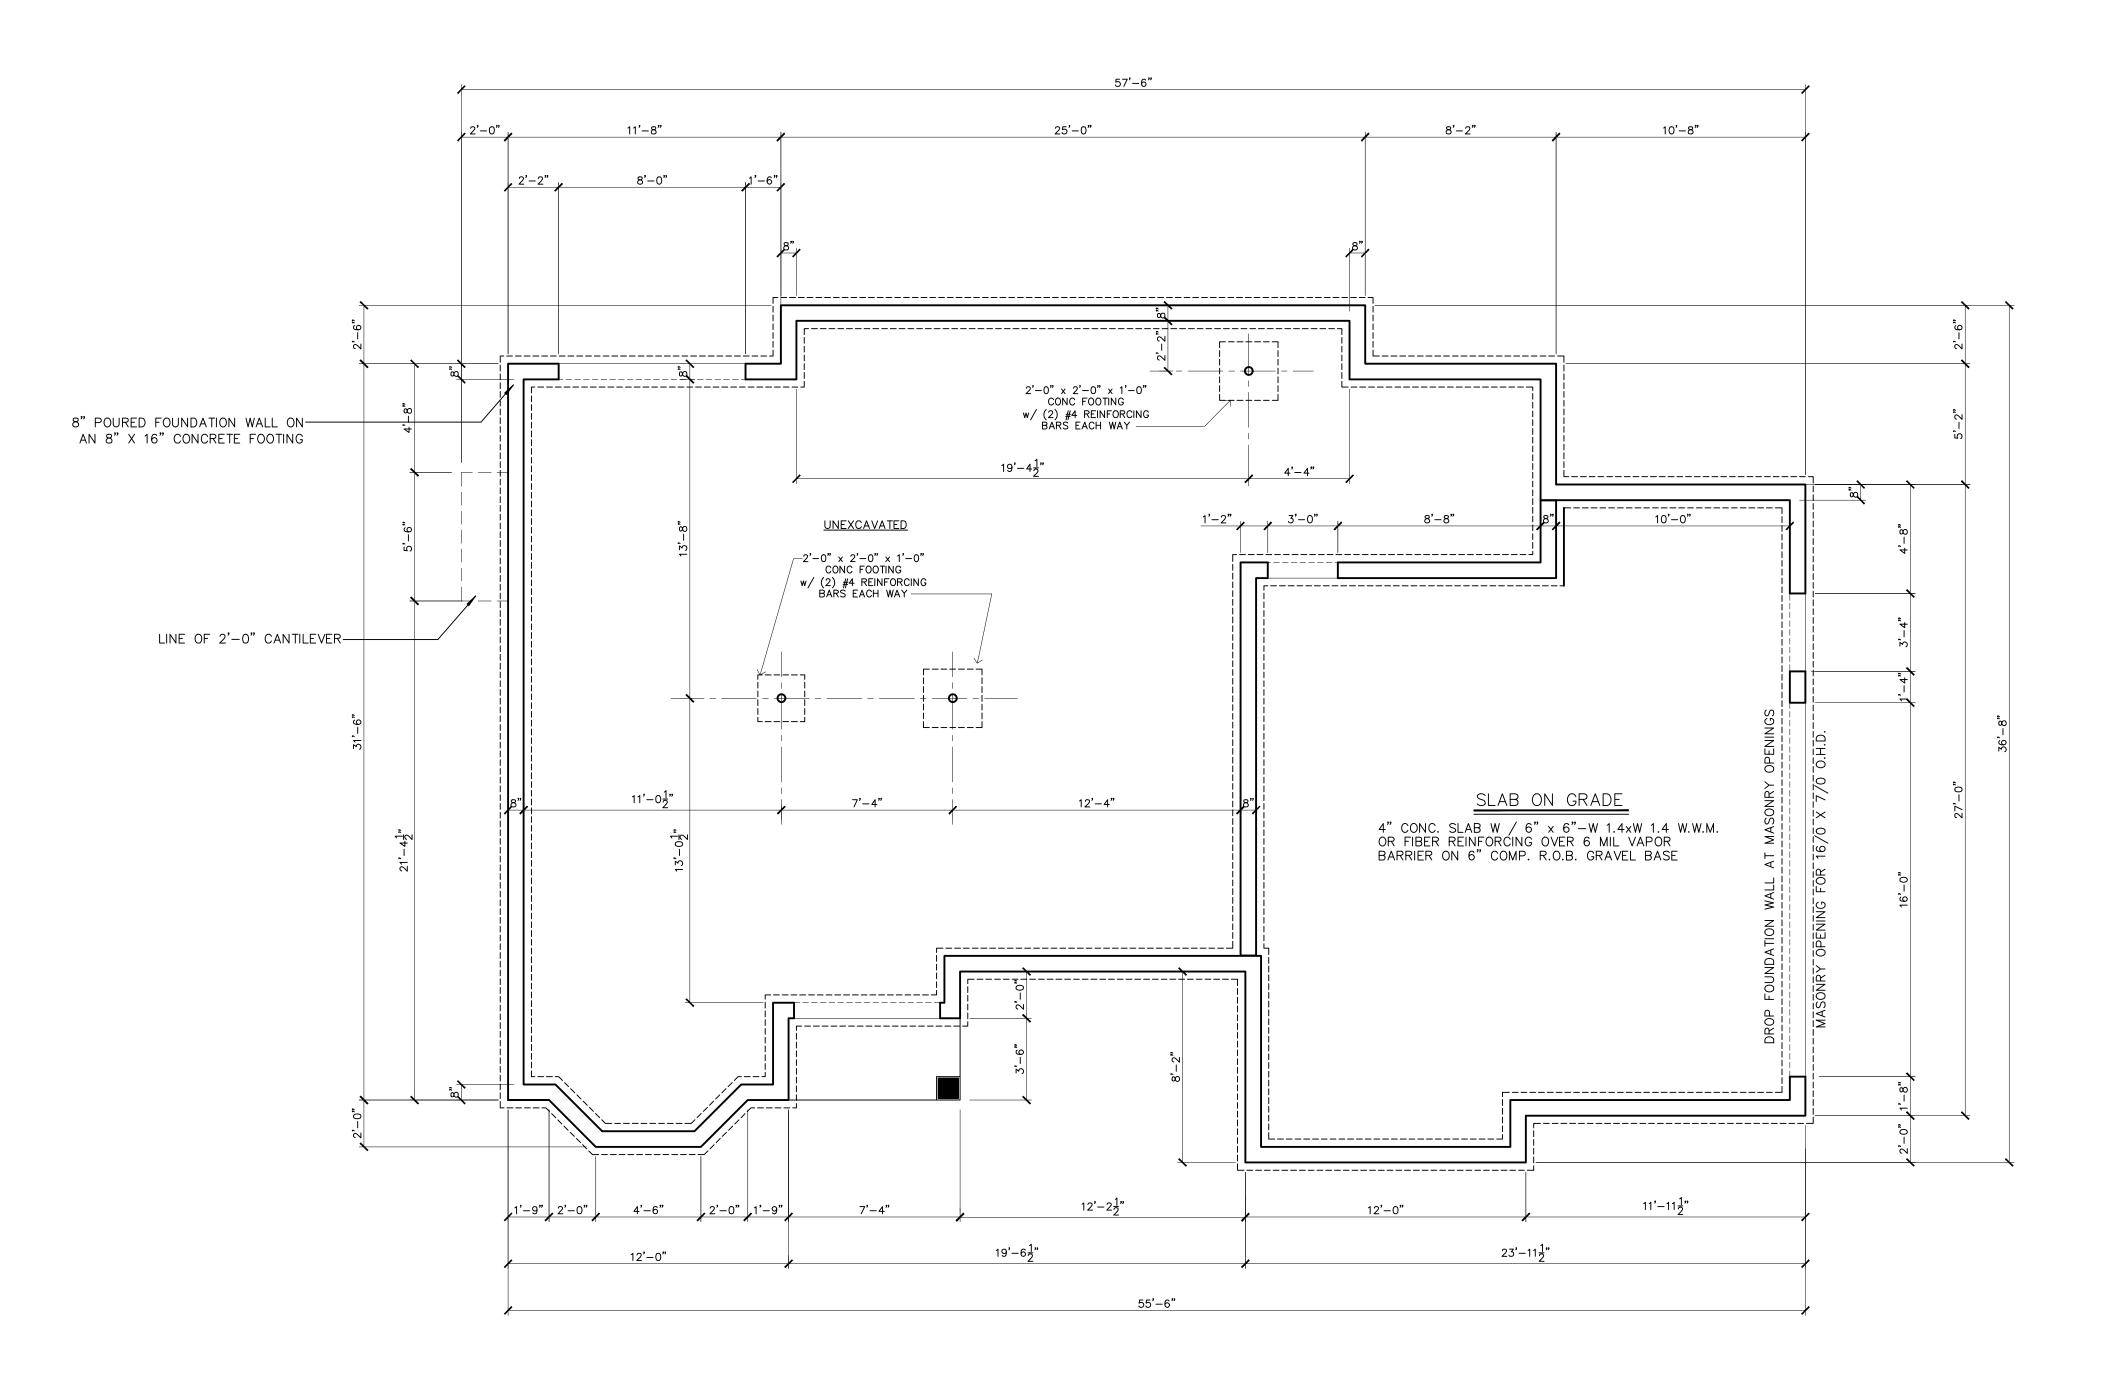
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CHECKED BY: M.E.G.
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SEPTEMBER 13, 2017

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SHEET No.

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FOUNDATION PLAN

SCALE: 1/4" = 1'-0"

NOTES:

ALL EXTERIOR WALLS ARE TO BE 2X6 WOOD STUDS
ALL INTERIOR WALLS ARE TO BE 2X4 WOOD STUDS

DOUBLE ALL FLOOR JOISTS UNDER WALLS ABOVE, THAT ARE FRAMED PARALLEL TO FLOOR FRAMING UNLESS OTHERWISE NOTED ON PLAN.

ALL FLOOR JOISTS, CEILING JOISTS & RAFTERS ARE TO BE S.P.F.

& RAFIERS ARE TO BE S.P.F.

ALL BEAMS, GIRDERS AND HEADERS
ARE TO BE DOUG FIR LARCH #2 OR
BETTER WITH A F6 RATING OF 875
AND A MODULUS OF ELASTICITY OF
1600000 MINIMUM UNLESS OTHERWISE
NOTED ON PLAN.

ALL LAMINATED VENEER LUMBER (L.V.L.)
BEAMS, GIRDERS AND HEADERS, LABELED
ON PLAN, TO HAVE A Fb RATING OF 2950
AND A MODULUS OF ELASTICITY OF 2,000,000
MINIMUM UNLESS OTHERWISE NOTED ON PLAN.
STRUCTURAL LAMINATED BEAMS TO BE INSTALLED
AS PER MANUFACTURERS SPECIFICATIONS.

CUTS, NOTCHES & HOLES BORED IN TRUSSES,
STRUCTURAL COMPOSITE LUMBER, STRUCTURAL
GLUE-LAMINATED MEMBERS OR I-JOISTS ARE
PROHIBITED EXCEPT WHERE PERMITTED BY THE

MANUFACTURER'S RECOMMENDATIONS.

FOR LOAD—BEARING PARTITIONS INSTALL DOUBLE JAMB STUDS UNDER HEADER FOR OPENINGS 6' AND LESS IN WIDTH. TRIPLE JAMB STUDS FOR WIDER OPENINGS. FOR NON—BEARING PARTITIONS INSTALL ONE JAMB STUD FOR OPENINGS LESS THAN 4' IN WIDTH AND DOUBLE JAMS STUDS FOR WIDER OPENINGS.

CONTRACTOR TO PROVIDE SOLID 2 X 10 BLOCKING TO BE LOCATED BETWEEN FLOOR JOISTS WERE POSTS, FROM ABOVE, CARRYING STRUCTURAL HEADERS LAND BETWEEN FLOOR JOISTS BELOW. BLOCKING TO BE BUILT UP TO THE SAME WIDTH AS POST IT IS CARRYING ABOVE. ALL JOISTS TO OVER LAP GIRDER OR BEARING WALL A MINIMUM OF 3".

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INSTALL 2 X 6 COLLAR TIES AT 32" O.C. COLLAR TIES TO BE LOCATED DOWN FROM THE MAIN RIDGE A MINIMUM OF 1/3RD OF THE TOTAL HEIGHT BETWEEN THE CEILING JOISTS AND THE TOP OF THE MAIN RIDGE.

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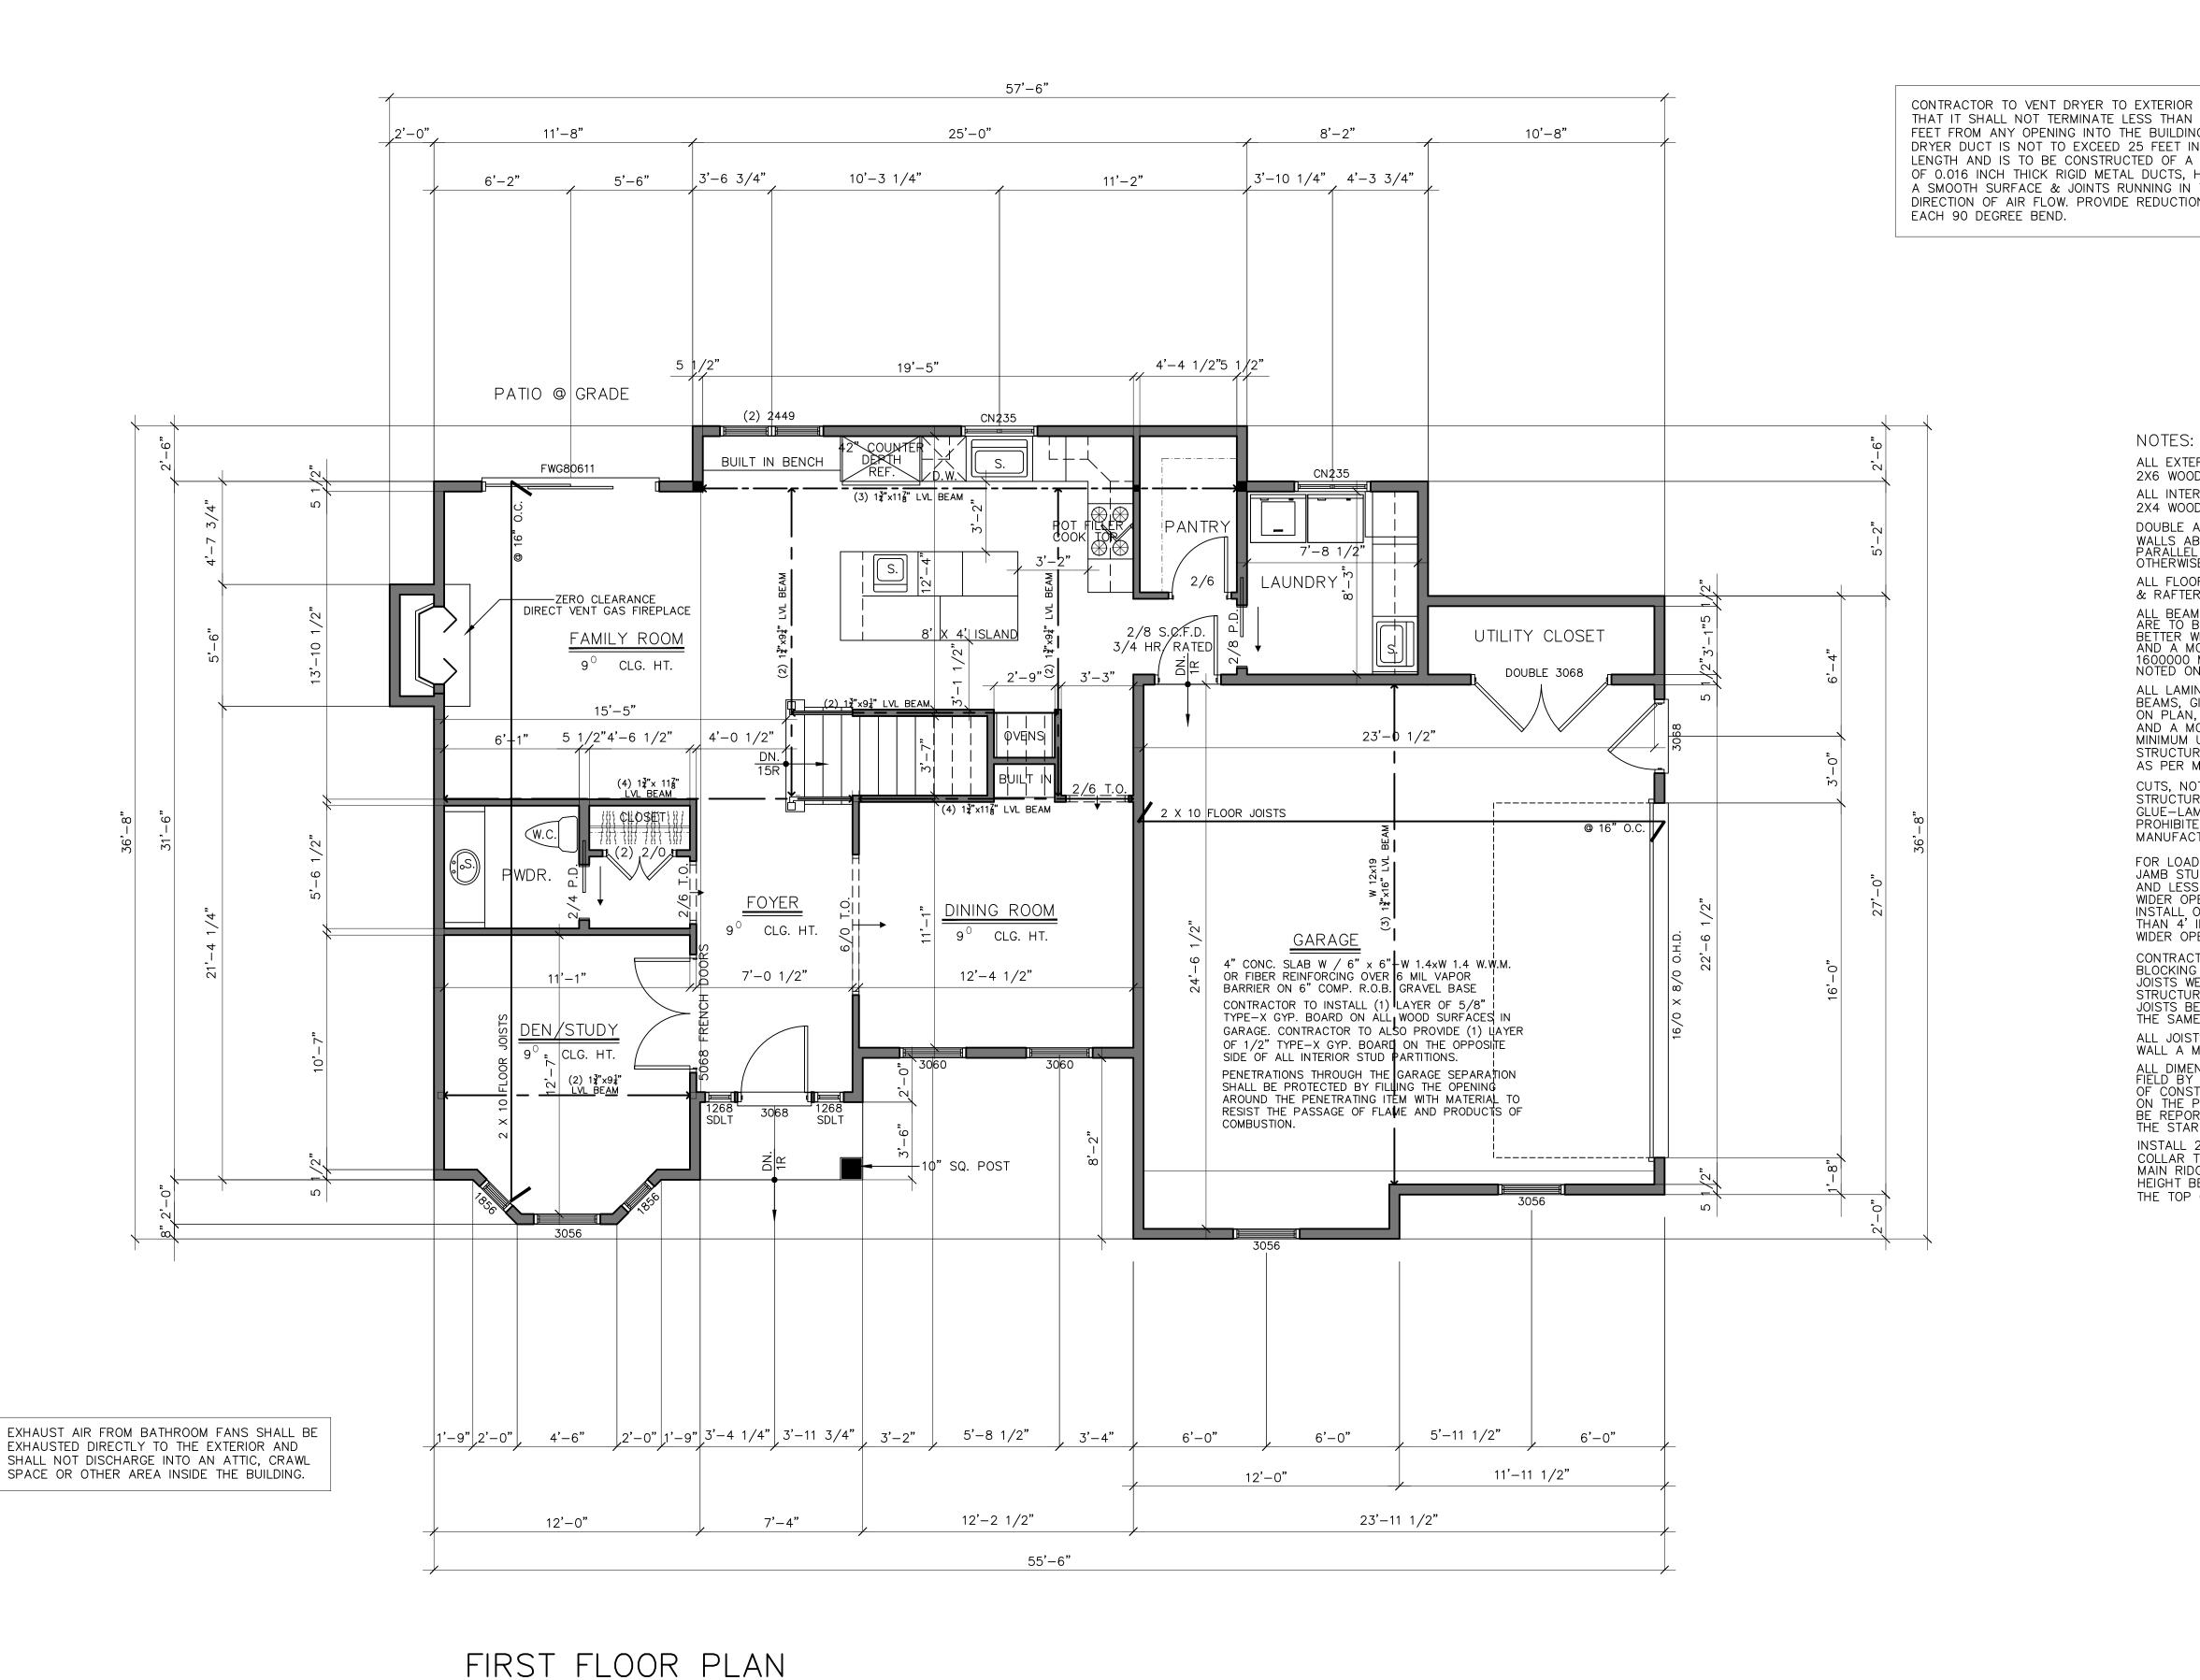
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OCTOBER 5, 2017

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CONTRACTOR TO VENT DRYER TO EXTERIOR SUCH THAT IT SHALL NOT TERMINATE LESS THAN 3 FEET FROM ANY OPENING INTO THE BUILDING. DRYER DUCT IS NOT TO EXCEED 25 FEET IN LENGTH AND IS TO BE CONSTRUCTED OF A MIN. OF 0.016 INCH THICK RIGID METAL DUCTS, HAVING A SMOOTH SURFACE & JOINTS RUNNING IN THE DIRECTION OF AIR FLOW. PROVIDE REDUCTION FOR

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SHEET No.

(S) INTERCONNECTED 110 VOLT SMOKE DETECTOR W/ BATTERY BACKUP TESTED IN ACCORDANCE WITH UL217 & NFPA72

© INTERCONNECTED CARBON MONOXIDE ALARM W/ BATTERY BACKUP TESTED IN ACCORDANCE WITH UL 2034 & CSA 6.19 -TO BE INSTALLED ON EACH FLOOR CONTAINING A SLEEPING AREA OR CARBON MONOXIDE SOURCE. TO BE INSTALLED WITHIN 15 FEET OF EACH SLEEPING AREA

SCALE: 1/4" = 1'-0"

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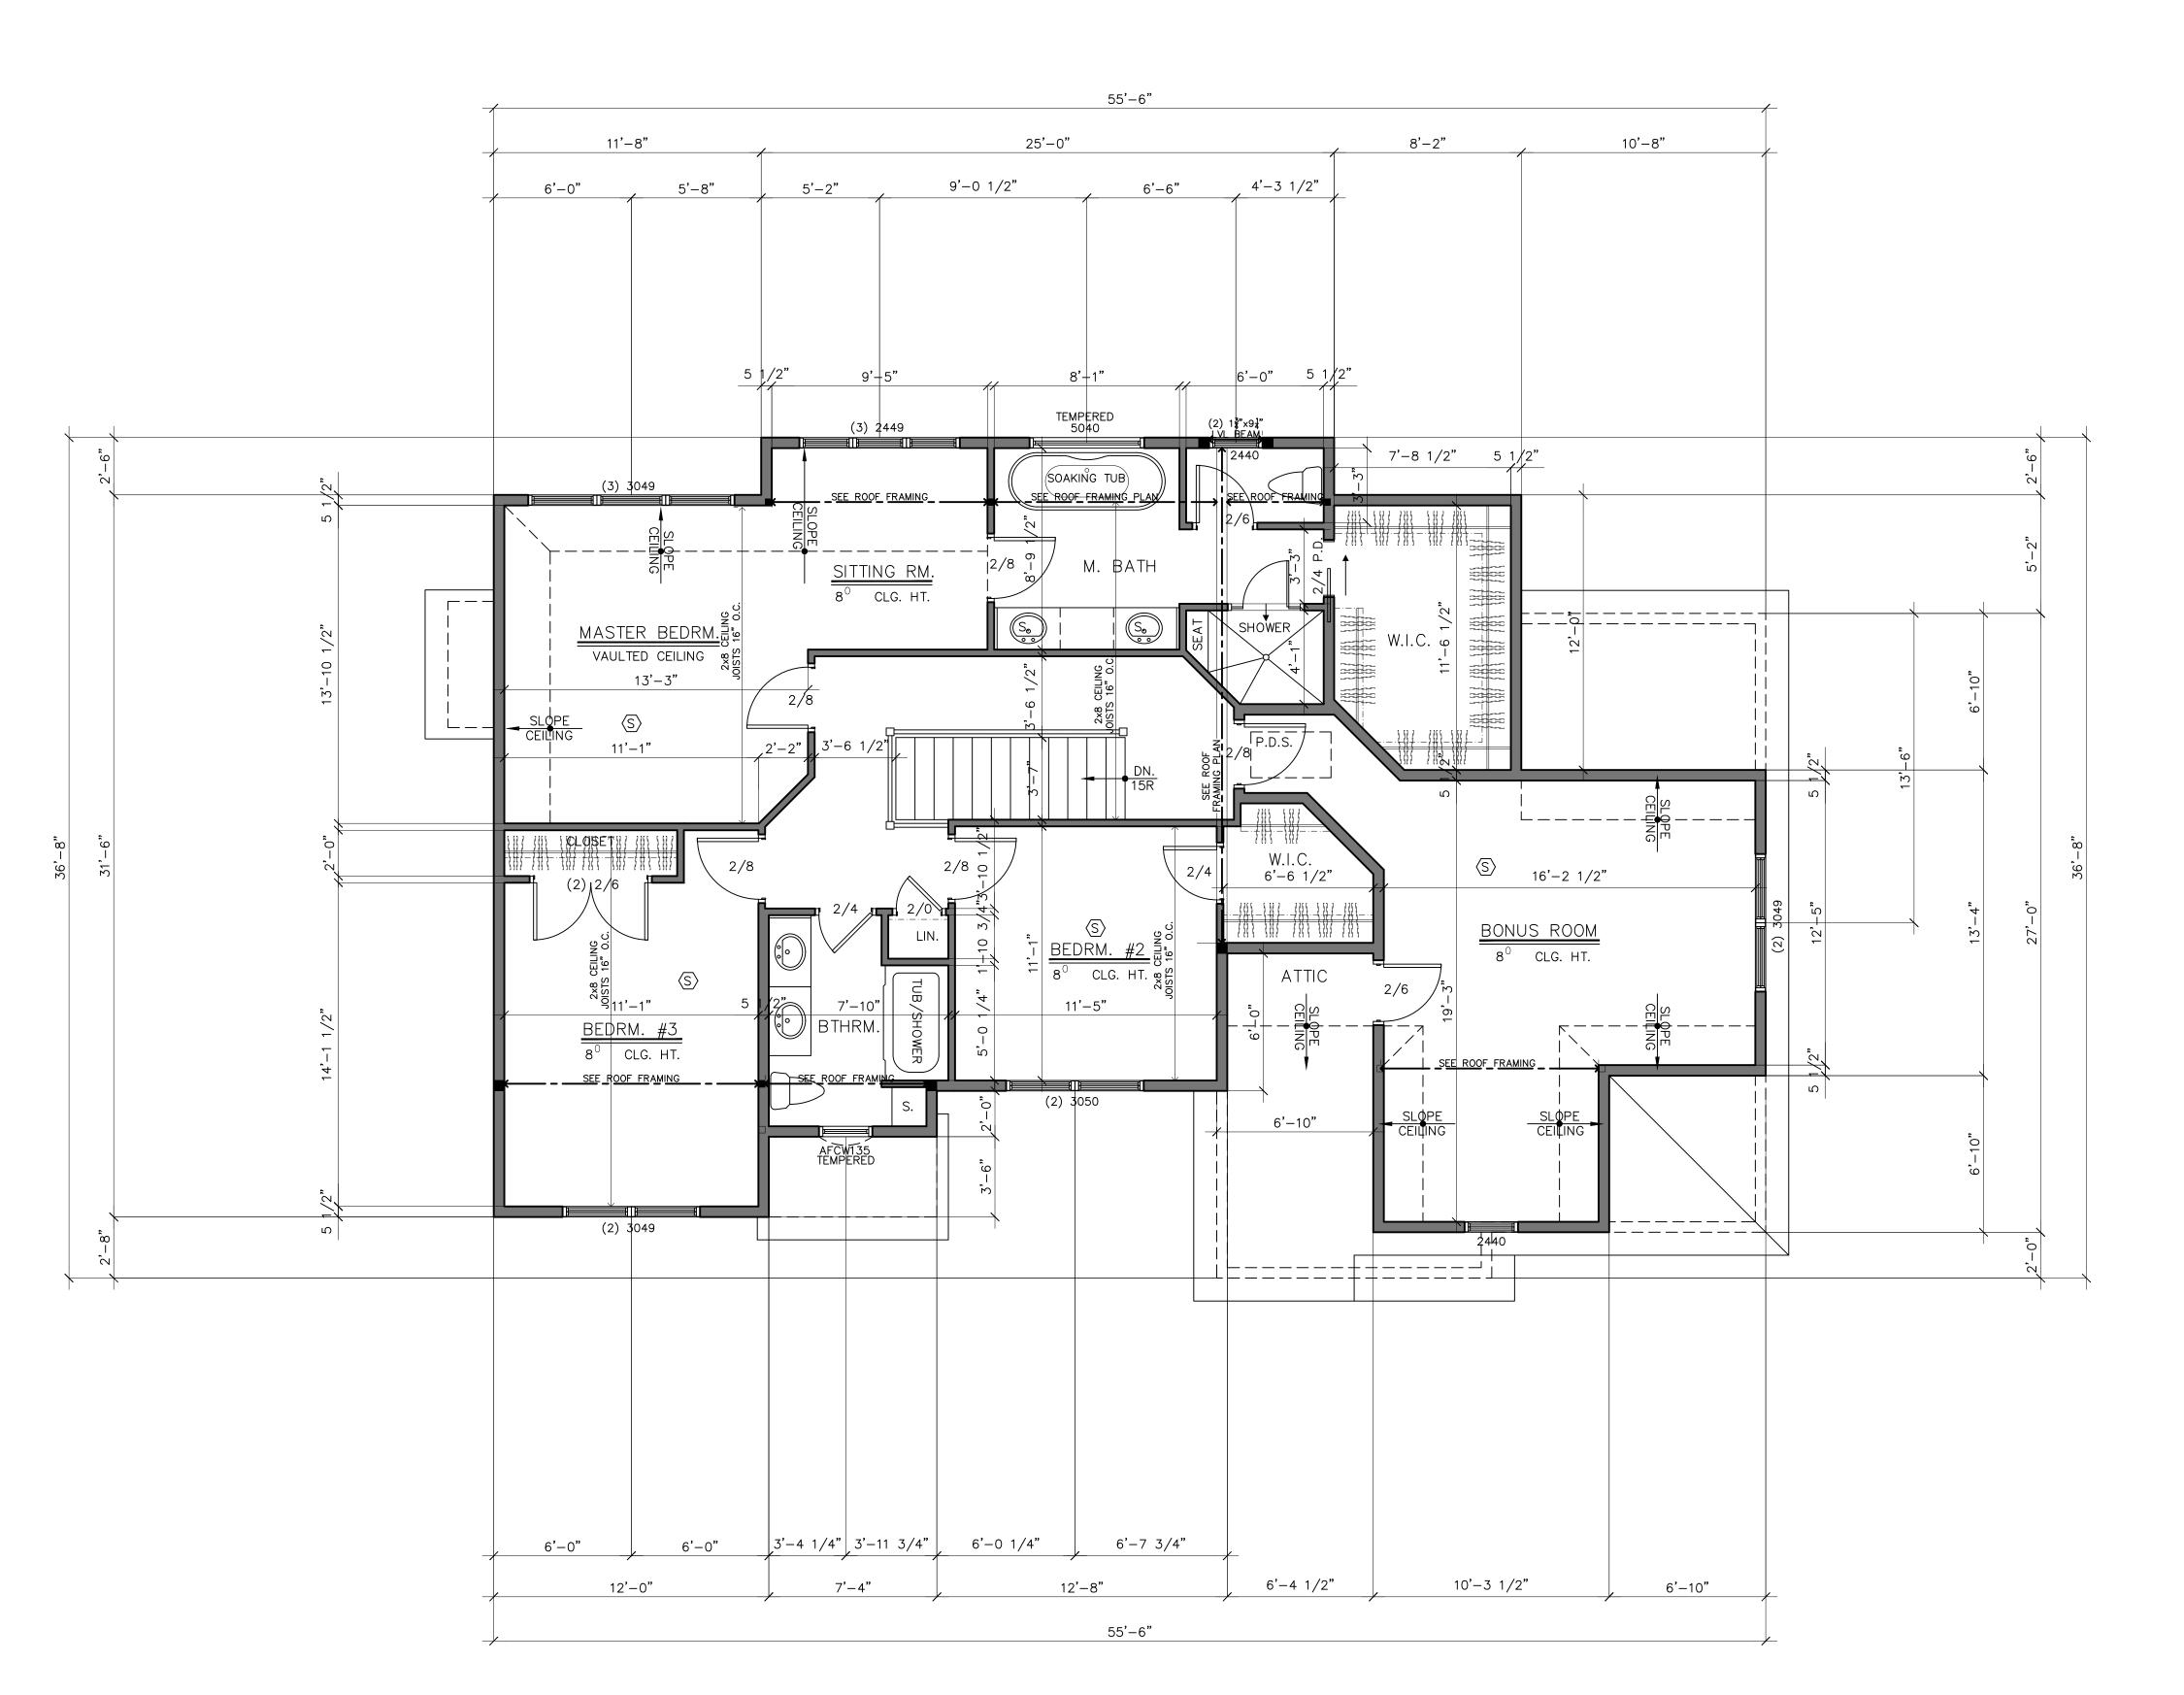
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DRAWN BY: M.E.G. CHECKED BY: REVISIONS SEPTEMBER 13, 2017 OCTOBER 9, 2017

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SECOND FLOOR PLAN

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-TO BE INSTALLED ON EACH FLOOR CONTAINING A SLEEPING AREA OR CARBON MONOXIDE SOURCE. TO BE INSTALLED WITHIN 15 FEET OF EACH SLEEPING AREA

SCALE: 1/4" = 1'-0"

NEW RESIDENCE FOR:
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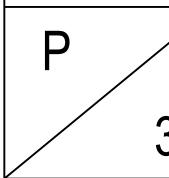
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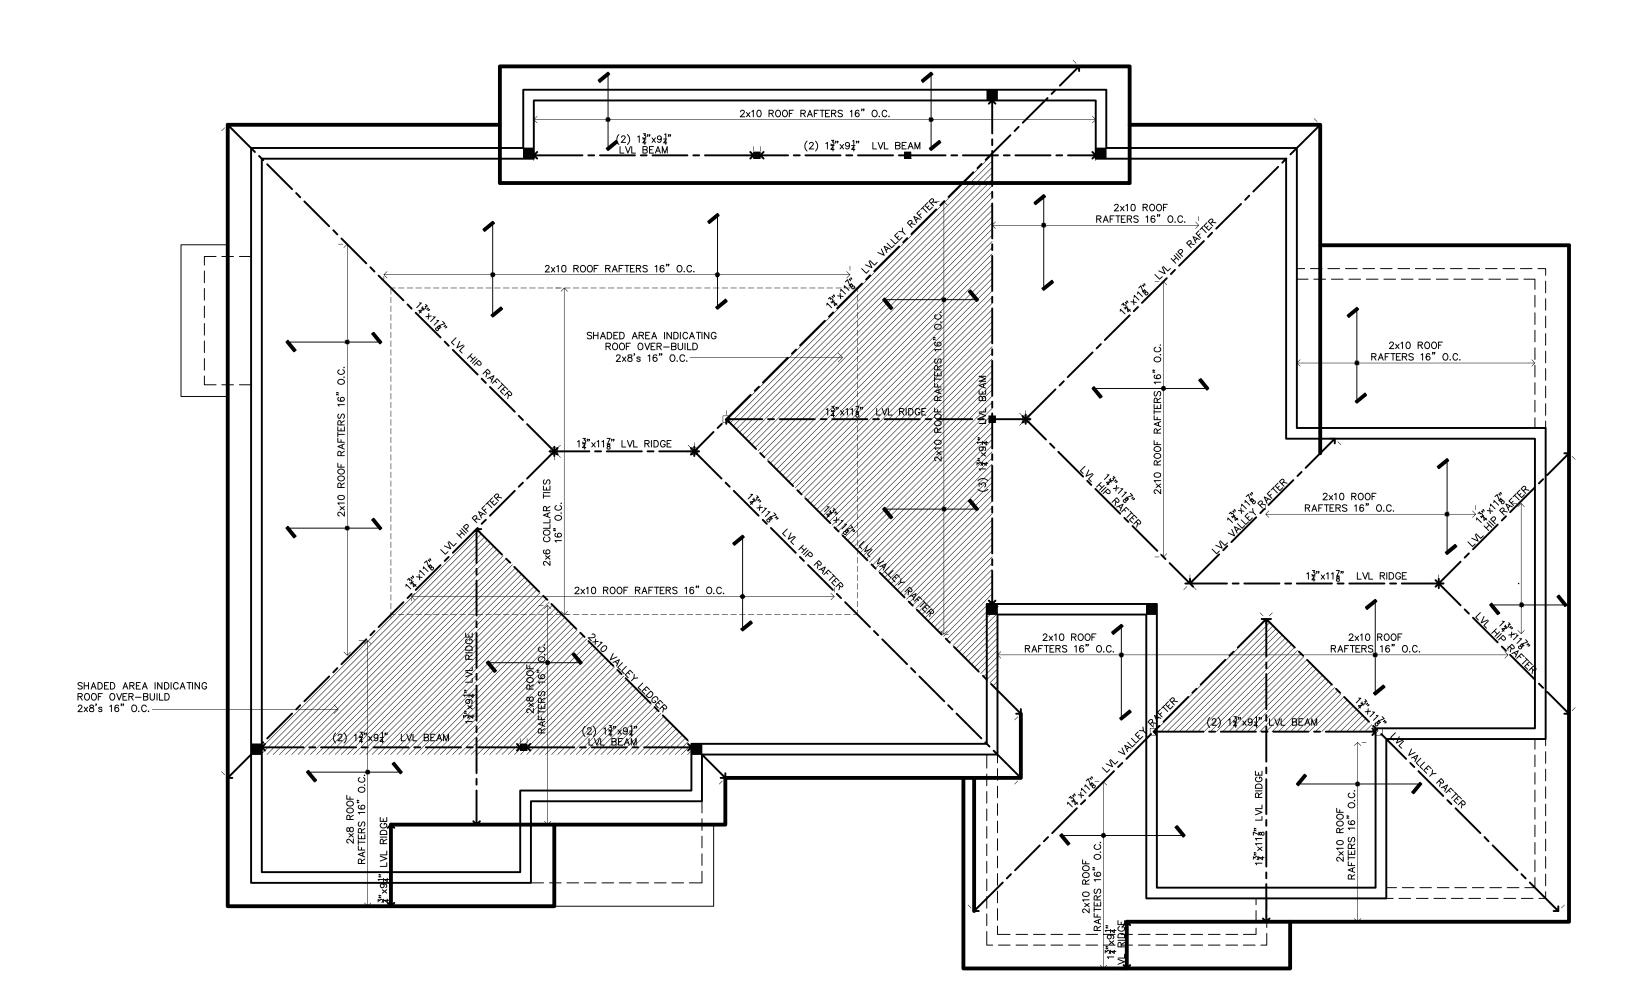
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ROOF FRAMING PLAN

SCALE: 1/4" = 1'-0"

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NEW YORK

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OF.

ROAD,

SOMERSTOWN

68A

Contreras

 $\Box$ 

Diesing

Stephanie

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CHECKED BY: M.E.G.
REVISIONS
SEPTEMBER 13, 2017
OCTOBER 6, 2017

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SHEET No.

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BUILDING TYPE: CODE DESIGN METHOD: CLIMATE ZONE:

SINGLE FAMILY RESIDENCE RESCHECK \*SEE ATTACHED

HEATING EQUIPMENT TYPE: SHALL BE DESIGNED BY THE H.V.A.C. CONTRACTOR

I, MICHAEL E. GILLESPIE CERTIFY THAT THESE PLANS AND SPECIFICATIONS COMPLY WITH THE APPLICABLE SECTIONS OF THE INTERNATIONAL ENERGY CONSERVATION CODE.

WOOD HEADER SIZES

SPANS UP TO AND INCLUDING:

0'-0" - 3'-11" 4'-0" - 5'-11" 6'-0" - 7'-11"

(2) 2x10's (2) 2x12's

MINIMUM HEADER SIZE

UNLESS OTHERWISE NOTED

THE BUILDING ENVELOPE SHALL BE CONSTRUCTED TO LIMIT AIR LEAKAGE. THE ENVELOPE SHALL BE TESTED AND VERIFIED TO HAVE AN AIR LEAKAGE RATE NOT EXCEEDING 3 AIR CHANGES PER HOUR AND A REPORTED PRESSURE OF 0.2 INCH W.G. (50 PASCALS). ALL DUCTS, AIR HANDLERS AND FILTER BOXES ARE TO BE SEALED. DUCTS ARE TO BE PRESSURE TESTED TO DETERMINE LEAKAGE.

A WHOLE HOUSE VENTILATION SYSTEM IS TO BE INSTALLED FOR THE NEW DWELLING. THE SYSTEM IS TO BE DESIGNED IN ACCORDANCE WITH M1507.3, THE SQUARE FOOTAGE OF THE DWELLING AND THE NUMBER OF BEDROOMS. OUTDOOR AIR INTAKES AND EXHAUSTS ARE TO HAVE AUTOMATIC OR GRAVITY DAMPERS THAT CLOSE WHEN SYSTEM IS NOT IN OPERATION.

FIREBLOCKING SHALL BE PROVIDED TO CUT OFF VERTICLE AND HORIZONTAL DRAFT OPENINGS AND TO FORM A FIRE BARRIER BETWEEN STORIES AND THE TOP STORY AND ROOF SPACE.

FIREBLOCKING IS TO BE PROVIDED IN THE FOLLOWING LOCATIONS: - IN CONCEALED STUD WALLS VERTICALLY AT CEILING & FLOOR LEVELS AND INTERVALS NOT EXCCEDING 10' - AT INERCONNECTIONS BETWEEN CONCEALED VERTICLE AND HORIZONTAL SPACES, SUCH AS SOFFITS, DROP CEILINGS, COVE

- IN CONCEALED SPACES BETWEEN STAIR STRINGERS AT THE TOP & BOTTOM OF THE RUN. FIREBLOCKING SHALL CONSIST OF NOMINAL TWO-INCH LUMBER, 23/32" PLYWOOD, 34" PARTICAL BOARD, 1/2" GYPSUM BOARD, 1/4" CEMENT BASED MILLBOARD OR BATTS/BLANKETS OF MINERAL WOOL

AT OPENINGS AROUND VENTS, PIPES, DUCTS, CABLES, AND WIRES AT THE CEILING AND FLOOR LEVEL AN APPROVED MATERAIL IS TO BE INSTALLED TO RESIST THE FREE PASSAGE OF FLAME & PRODUCTS OF COMBUSTION.

OR GLASS FIBER SECURELY RETAINED IN PLACE.

## GENERAL NOTES

#### <u>DIVISION 1 — GENERAL CONDITIONS:</u>

CODES: ALL WORK & MATERIALS MUST CONFORM TO THE 2015 INTERNATIONAL RESIDENTIAL CODE, LOCAL BUILDING CODES, NATIONAL BOARD OF FIRE UNDERWRITERS CODE AND TO THE REQUIREMENTS OF THE BOARD OF HEALTH & 2015 INTERNATIONAL ENERGY CONSERVATION CODE.

OMISSION: ANYTHING NOT SPECIFICALLY SHOWN HEREON AND/OR SPECS, BUT WHICH IS REASONABLY IMPLIED, SHALL BE FURNISHED AS THOUGH SET FORTH IN THE PLANS AND/OR SPECIFICATIONS. ALL WRITTEN FIGURES, NOTES & DIMENSIONS ON THE FLOOR PLANS, OR SPECIFICATIONS SHALL TAKE PRECEDENCE OVER ANY DRAWN FIGURES. DO NOT SCALE PRINTS. ALL DIMENSIONS MUST BE VERIFIED IN THE FIELD BY THE CONTRACTOR BEFORE START OF CONSTRUCTION. ANY DISCREPANCIES ON THE PLANS, OR SPECIFICATIONS, MUST BE REPORTED TO THE ENGINEER PRIOR TO THE START OF CONSTRUCTION.

ALL PERMITS ARE NOT THE RESPONSIBILITY OF THE ENGINEER.

MATERIALS: ALL MATERIALS SHALL BE NEW AND INSTALLED IN ACCORDANCE WITH THE MANUFACTURER'S SPECIFICATIONS.

SUBSTITUTIONS: SUBSTITUTIONS MADE FOR STRUCTURAL MATERIALS SPECIFIED BY NAME MAY BE MADE ONLY IF APPROVED BY ENGINEER.

OWNERSHIP OF PLANS: THESE PLANS ARE PROPERTY OF GILLESPIE & STOKOSA CONSULTING ENGINEERING, P.L.L.C. ANY USE OR REPRODUCTION, IN WHOLE OR PART, WITHOUT THE WRITTEN CONSENT OF GILLESPIE & STOKOSA IS PROHIBITED. ANY PERSON, OR CORPORATION, USING PLANS WITHOUT CONSENT WILL BE RESPONSIBLE TO COMPENSATE GILLESPIE & STOKOSA.

ENGINEER'S STATUS: THE ENGINEER HAS NOT BEEN RETAINED BY OWNER TO PROVIDE PERIODIC JOB INSPECTIONS OR JOB ADMINISTRATION AND SHALL NOT BE RESPONSIBLE FOR CHANGES MADE IN THE FIELD WITHOUT WRITTEN OR GRAPHIC AUTHORIZATION.

## <u>DIVISION 2 - SITE WORK:</u>

FOOTINGS: IF SOIL BEARING CONDITIONS ARE QUESTIONABLE, THE CONTRACTOR SHALL CONSULT A SOILS ENGINEER FOR PROPER FOOTING DESIGN. THE PLANS ARE BASED ON A MINIMUM SOIL BEARING CAPACITY 2,000 PSF.

FINISHED GRADING: FINISHED GRADING SHALL BE PERFORMED SO AS TO PROVIDE POSITIVE DRAINAGE AWAY FROM THE HOUSE.

## <u>DIVISION 3 – CONCRETE:</u>

ALL CONCRETE USED SHALL HAVE A MINIMUM COMPRESSIVE STRENGTH OF 3,500 PSI AT 28 DAYS UNLESS OTHERWISE NOTED. ALL CONCRETE WORK SHALL BE DONE IN COMPLETE CONFORMANCE TO APPLICABLE ACI CODES.

## <u>DIVISION 5 - METALS:</u>

STRUCTURAL STEEL: ALL STRUCTURAL STEEL SHALL CONFORM TO ASTM SPECIFICATIONS A-36 FOR STRUCTURAL STEEL. ALL STEEL PIPE COLUMNS SHALL BE OF STANDARD WEIGHT PIPE UNLESS OTHERWISE NOTED. STRUCTURAL STEEL HAS BEEN DESIGNED FOR A MAXIMUM BENDING STRESS OF 24,000 PSI, IN ACCORDANCE WITH THE 9TH EDITION OF THE AISC. ALL STEEL BEAMS SHAL BE FACTORY PRIMED WITH A RUST PROHIBITOR AND FIELD PAINTED WHERE EXPOSED TO WEATHER. ALL BEAM CONNECTIONS SHALL BE THROUGH BOLTED UNLESS OTHERWISE NOTED. ALL HOLES SHALL BE DRILLED OR PUNCHED. TORCHED HOLES SHALL NOT BE PERMITTED.

REINFORCING STEEL: ALL REINFORCING STEEL BARS SHALL BE GRADE 60.

## <u>DIVISION 6 - WOOD & PLASTICS:</u>

LUMBER: ALL STRUCTURAL LUMBER SHALL HAVE A MINIMUM BENDING STRESS OF 1,200 PSI.

FRAMING: FRAMING SHALL BE ERECTED PLUMB, LEVEL, TRUE AND SECURELY NAILED. JOISTS, STUDS AND RAFTERS ARE TO BE DOUBLED AT ALL OPENINGS. ALL FLUSH JOIST HEADERS TO BE CONNECTED WITH GALVANIZED METAL JOIST HANGERS. ALL FLUSH BEAM CONNECTIONS SHALL HAVE HEAVY DUTY JOIST HANGERS. DOUBLE FRAME UNDER ALL PARTITIONS PARALLEL TO FRAMING. SIZES OF JOISTS AND RAFTERS ARE SHOWN ON THE PLAN. IF A WOOD DECK IS PROVIDED, ALL STRUCTURAL MEMBERS SHALL BE PRESSURE TREATED LUMBER.

SHEATHING & SUBFLOOR: SHEATHING & SUBFLOOR SHALL BE APA ORIENTED STRAND BOARD WITH EXTERIOR GLUE AND NAILED TO EACH FRAMING MEMBER UNLESS OTHERWISE NOTED.

JOIST HANGERS: JOIST HANGERS SHALL BE GALVANIZED STEEL OR IRON, SIZED TO FIT THE SUPPORTED MEMBER AND OF SUFFICIENT STRENGTH TO DEVELOP THE FULL STRENGTH OF THE SUPPORTED MEMBER, AND FURNISHED COMPLETE WITH ANY SPECIAL FASTENERS REQUIRED. MANUFACTURES SHALL BE "SIMPSON" STRONG-TIE, OR EQUAL.

## <u>DIVISION 7 - THERMAL & MOISTURE PROTECTION:</u>

ROOFING: ALL CHIMNEYS SHALL BE PROPERLY FLASHED WITH GALVANIZED STEP FLASHING. VALLEY AND VERTICAL ROOF SECTIONS SHALL BE PROPERLY SUPPORTED. ALL ROOFING SHALL BE INSTALLED IN STRICT CONFORMANCE TO THE MANUFACTURER'S SPECIFICATIONS.

## ASPHALT SHINGLES: TO BE SELECTED BY OWNER OR CONTRACTOR.

VENTS: VENTILATE ALL ATTIC, RAFTER AND CRAWL SPACE AREAS WITH PROPER SIZED SCREENED VENTS AND/OR LOUVERS.

INSULATION: ALL INSULATION SHALL BE INSTALLED IN ACCORDANCE WITH THE 2015 IECC.

CAULKING: ALL EXTERIOR JOINTS BETWEEN WINDOWS, DOORS AND OTHER SURFACES SHALL BE CAULKED USING A WEATHERPROOF CAULKING.

## DIVISION 8 - DOORS & WINDOWS:

WINDOWS: ALL WINDOWS SHALL MEET THE MINIMUM REQUIREMENTS FOR LIGHT, VENTILATION AND EGRESS. ALL WINDOWS SHALL BE OF SUFFICIENT CONSTRUCTION SO AS TO MEET THE 2015 IECC.

INTERIOR DOORS: ALL INTERIOR DOORS SHALL COME COMPLETE WITH HARDWARE. A CLASS "C" SELF-CLOSING FIRE RATED DOOR SHALL BE FURNISHED AND INSTALLED BETWEEN GARAGE & HOUSE. ALL DOORS SHALL MEET THE MINIMUM REQUIREMENTS OF THE 2015 IECC, IF APPLICABLE.

## <u>DIVISION 9 - FINISHES:</u>

DRYWALL: DRYWALL SHALL BE 1/2" GYPSUM BOARD SECURELY SCREWED ACCORDING TO THE MANUFACTURER'S SPECIFICATIONS. ALL JOINTS ARE TO BE TAPED AND SHALL RECEIVE (3) COATS OF JOINT COMPOUND. FINISHES TO BE SMOOTH, EVEN AND READY FOR PAINTING.

## <u>DIVISION 15 - MECHANICAL:</u>

HEATING: THE CONTRACTOR SHALL FURNISH & INSTALL A HEATING SYSTEM WHICH MEETS THE 2015 IECC.

FLASHING: ALL PIPES PASSING THROUGH ROOF SHALL BE MADE WATER-

ALL PIPES CARRYING WATER OVER 105 DEGREES MUST BE INSULATED WITH


A MINIMUM OF R-3. TESTING: THE CONTRACTOR SHALL TEST ALL WATER SUPPLY AND DRAIN,

WASTE AND VENT PIPING IN ACCORDANCE WITH ALL CODES.

## <u>DIVISION 16 - ELECTRICAL:</u>

ALL ELECTRICAL WORK SHALL BE DONE IN STRICT CONFORMANCE WITH THE NATIONAL BOARD OF FIRE UNDERWRITERS AND LOCAL CODES. THE SERVICE SIZE SHALL BE A MINIMUM OF 100 AMPS.

FOR ASPHALT SHINGLED ROOFS, IN ADDITION TO MEETING THE REQUIREMENTS OF SECTIONS R905.2 ASPHALT SHINGLES OF THE 2015 IRC, SHINGLES SHALL ALSO BE INSTALLED IN STRICT ACCORDANCE WITH MANUFACTURER

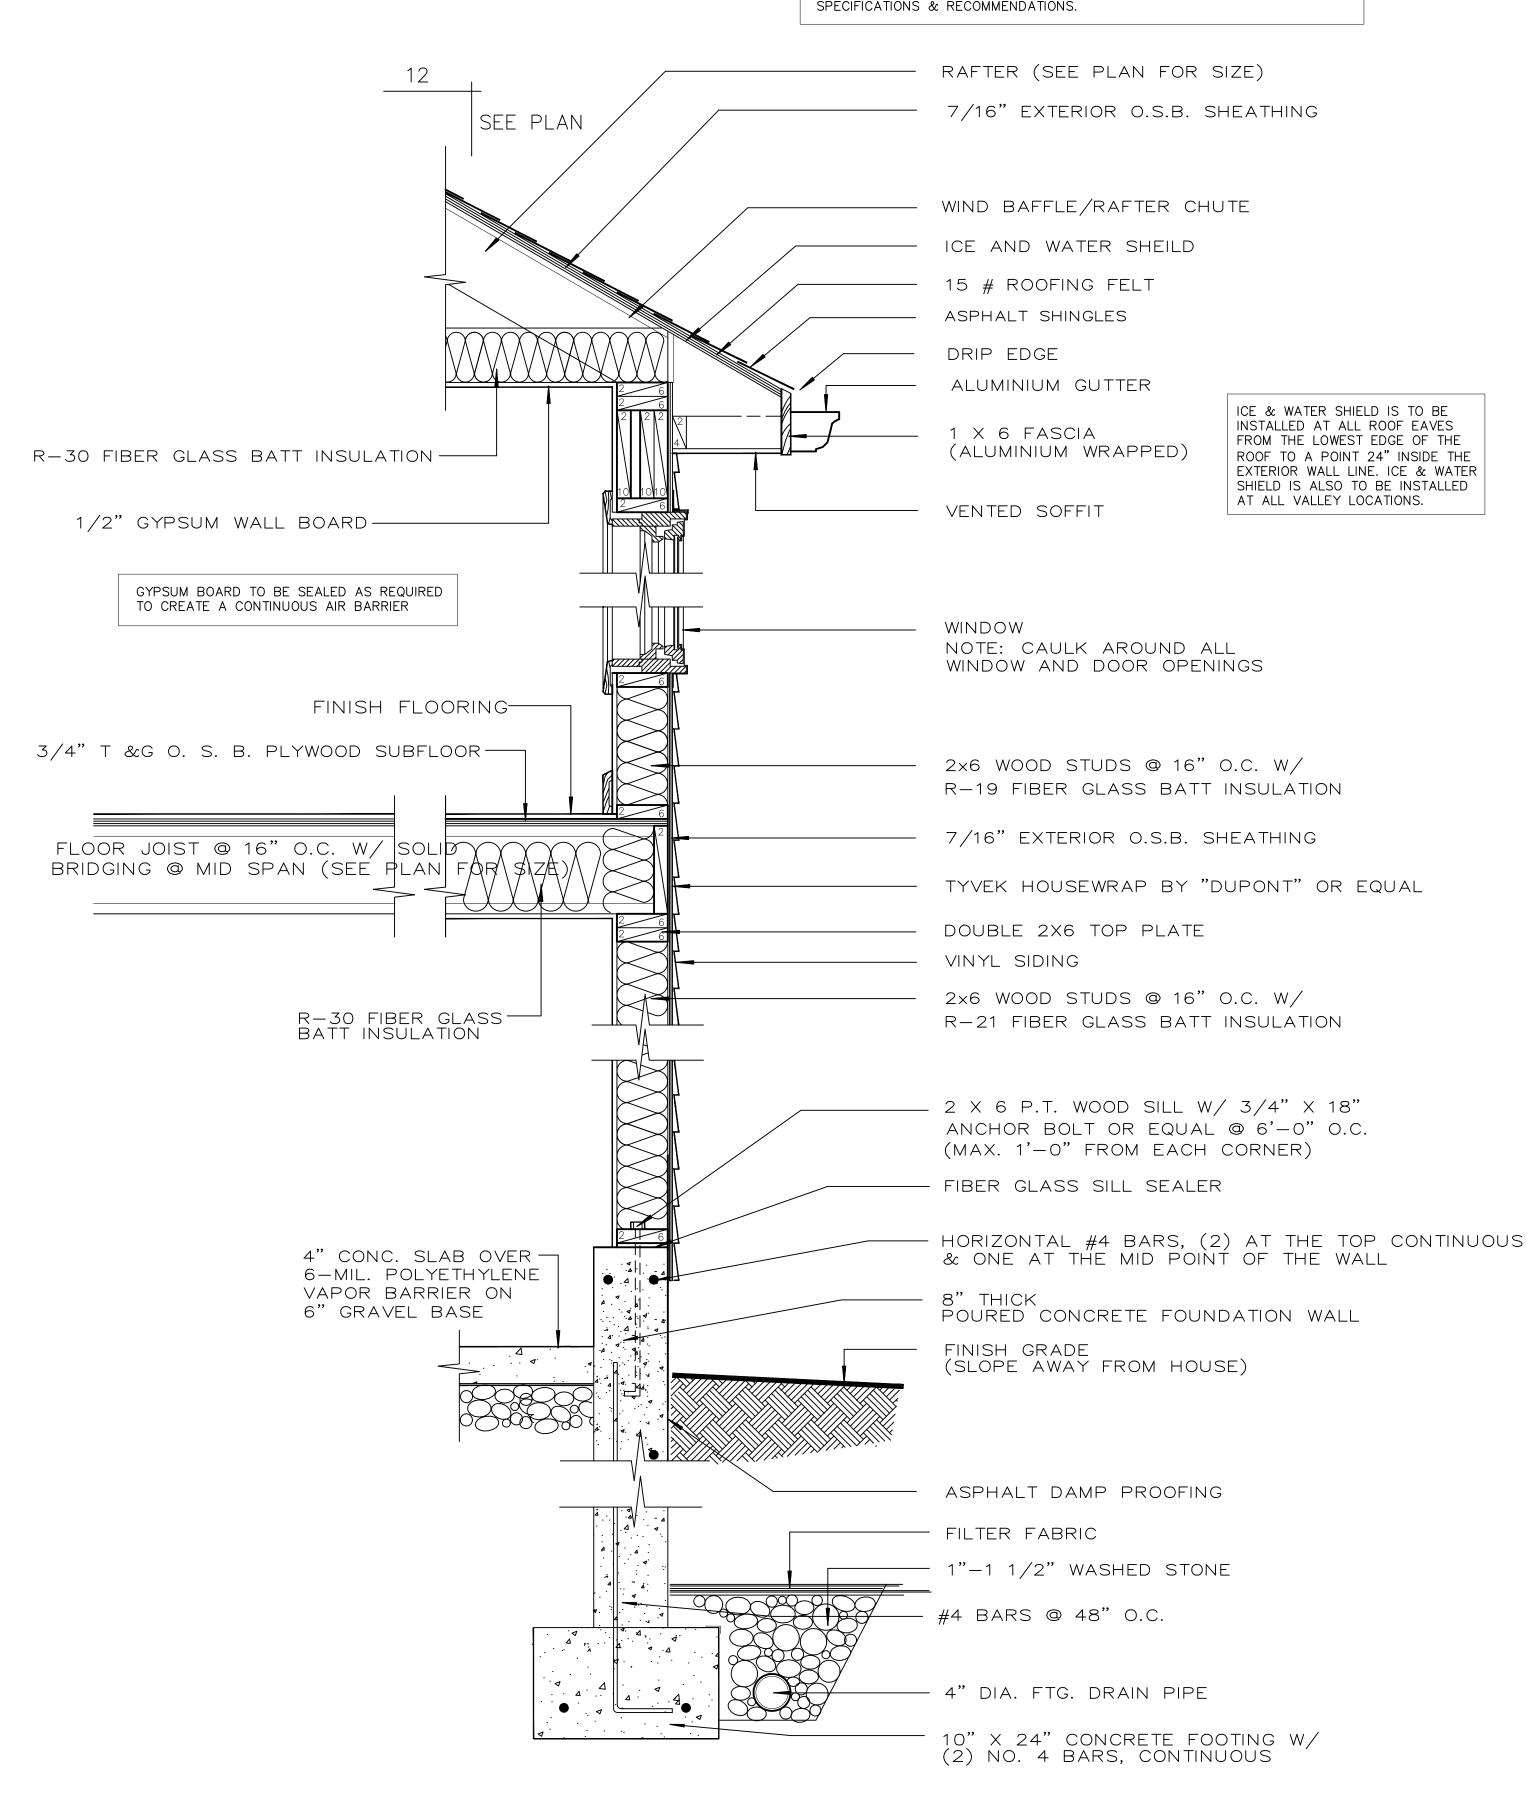

TYPICAL WALL SECTION FOR SLAB ON GRADE CONSTRUCTION

SCALE: N.T.S.

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NWO.

DRAWN BY: CHECKED BY: M.E.G. REVISIONS OCTOBER 6, 2017

NYSPE #074666

SHEET No.



## Classic-Craft® Rustic Collection™ \$\$ 2 Panel Soft Arch | Style No. CCR200 6

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1 Available Size 3'0" x 6'8"



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**3** Available Sizes 2'8" x 6'8" 2'10" x 6'8" 3'0" x 6'8"





#### **Applied Products:**



Garage Door

Carriage House Steel

6600 Panel 16' x 7'

Paint

White

White

Hardware Pull Handle

Aspen 16' x 7'