


LOCATION MAP

BASE MAP SOURCE: WESTCHESTER GIS

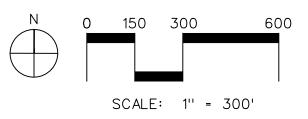

OWNER/APPLICANT:

PAUL SCHEMMER, VALERIE SCHEMMER 37 Croton Dam Road Ossining, NY 10562

VAL SANTUCCI, MICHELLA SANTUCCI 37 Croton Dam Road Ossining, NY 10562

37 - 41 CROTON DAM ROAD TOWN OF OSSINING, NEW YORK

APPLICATION FOR SUBDIVISION APPROVAL MAY 29, 2018 REVISED: SEPTEMBER 24, 2018

ZONING COMPLIANCE TABLE

R-15 DISTRICT	REQUIRED/ PERMITTED	EXIS	PROPOSED				
		37 Croton Dam Rd	41 Croton Dam Rd	Lot 1	Lot 2	Lot 3	Lot 4
CHAPTER 200 - ZONING		Section 89.08 - Block 1 - Lot 82	Section 89.08 - Block 1 - Lot 81				
Attachment 2 - Bulk Regulations							
Lot Area (sf)	15,000	140,611	79,279	91,070	34,189	60,509	36,819
Lot Width (feet)	90	335	187	273	205	166	124
Lot Depth (feet)	120	415	450	236	141	168	269
Required Yards							
Front (feet)	30	57	N/A	42	57	67	127
1 Side (feet)	14	97	N/A	58	56	26	27
Both Sides (feet)	30	257	N/A	217	134	138	75
Rear (feet)	32	134	N/A	122	45	32	79
Max Building Height							
Stories	2.5	2	N/A	1	2	< 2.5	< 2.5
Feet	35	No Change	N/A	No Change	No Change	< 35	< 35
Max Building Coverage (percent)	25	4.7	N/A	6%	8%	5%	8%
CHAPTER 176 - SUBDIVISION REGULATIONS							
Section 176-18F(1) ¹ - Lots							
Area Exclusive of Extremely Steep Slopes ² (sf)							
Required	75% of lot area	11,250	11,250	11,250	11,250	11,250	11,250
Provided							
Total Lot Area		140,611	79,279	91,070	34,189	60,509	36,819
Less Extremely Steep Slopes		17,500	13,500	8,500	8,250	12,500	9,200
Provided Net Lot Area		123,111	65,779	82,570	25,939	48,009	27,619

¹Per subdivision code section 176-18F(1), "...at least 75% of the minimum lot area requirement of a proposed lot shall consist of niether 'wetland' nor 'extremely steep slope'... ²Per Chapter 167 of the Steep Slope Protection code, an extremely steep slope is defined as a slope with a topographical gradient equal to or greater than 35%

LIST OF DRAWINGS

COVER SHEET	
SP-0.0	PRELIMINARY SUBDIVISIO
SP-1.0	SITE LAYOUT PLAN
SP-2.0	SITE ENGINEERING PLAN_
SP-3.1	LANDSCAPE PLAN
SP-4.1 - 4.2	SITE DETAILS
SP-5.0	TREE REMOVAL PLAN
SP-5.1	EROSION AND SEDIMENT
SP-6.0	STEEP SLOPES
SP-7.0	ROAD PROFILES
	SURVEY


PLANNER, CIVIL ENGINEER, LANDSCAPE ARCHITECT:

DIVNEY + TUNG + SCHWALBE Intelligent Land Us


Divney Tung Schwalbe, LLP One North Broadway White Plains, NY 10601 P: 914.428.0010 F: 914.428.0017

SURVEYOR: THOMAS C. MERRITTS Land Surveyors, P.C. 394 Bedford Road Pleasantville, NY 10507 SCALE

INARY SUBDIVISION PLAN	1" = 30'
YOUT PLAN	1" = 30'
GINEERING PLAN	1" = 30'
CAPE PLAN	1" = 30'
TAILS	AS NOTED
EMOVAL PLAN	1" = 30'
N AND SEDIMENT CONTROL PLAN & DETAILS	1" = 30'
SLOP <u>ES</u>	1'' = 40'
PROFILES	AS NOTED
{	1" = 30'

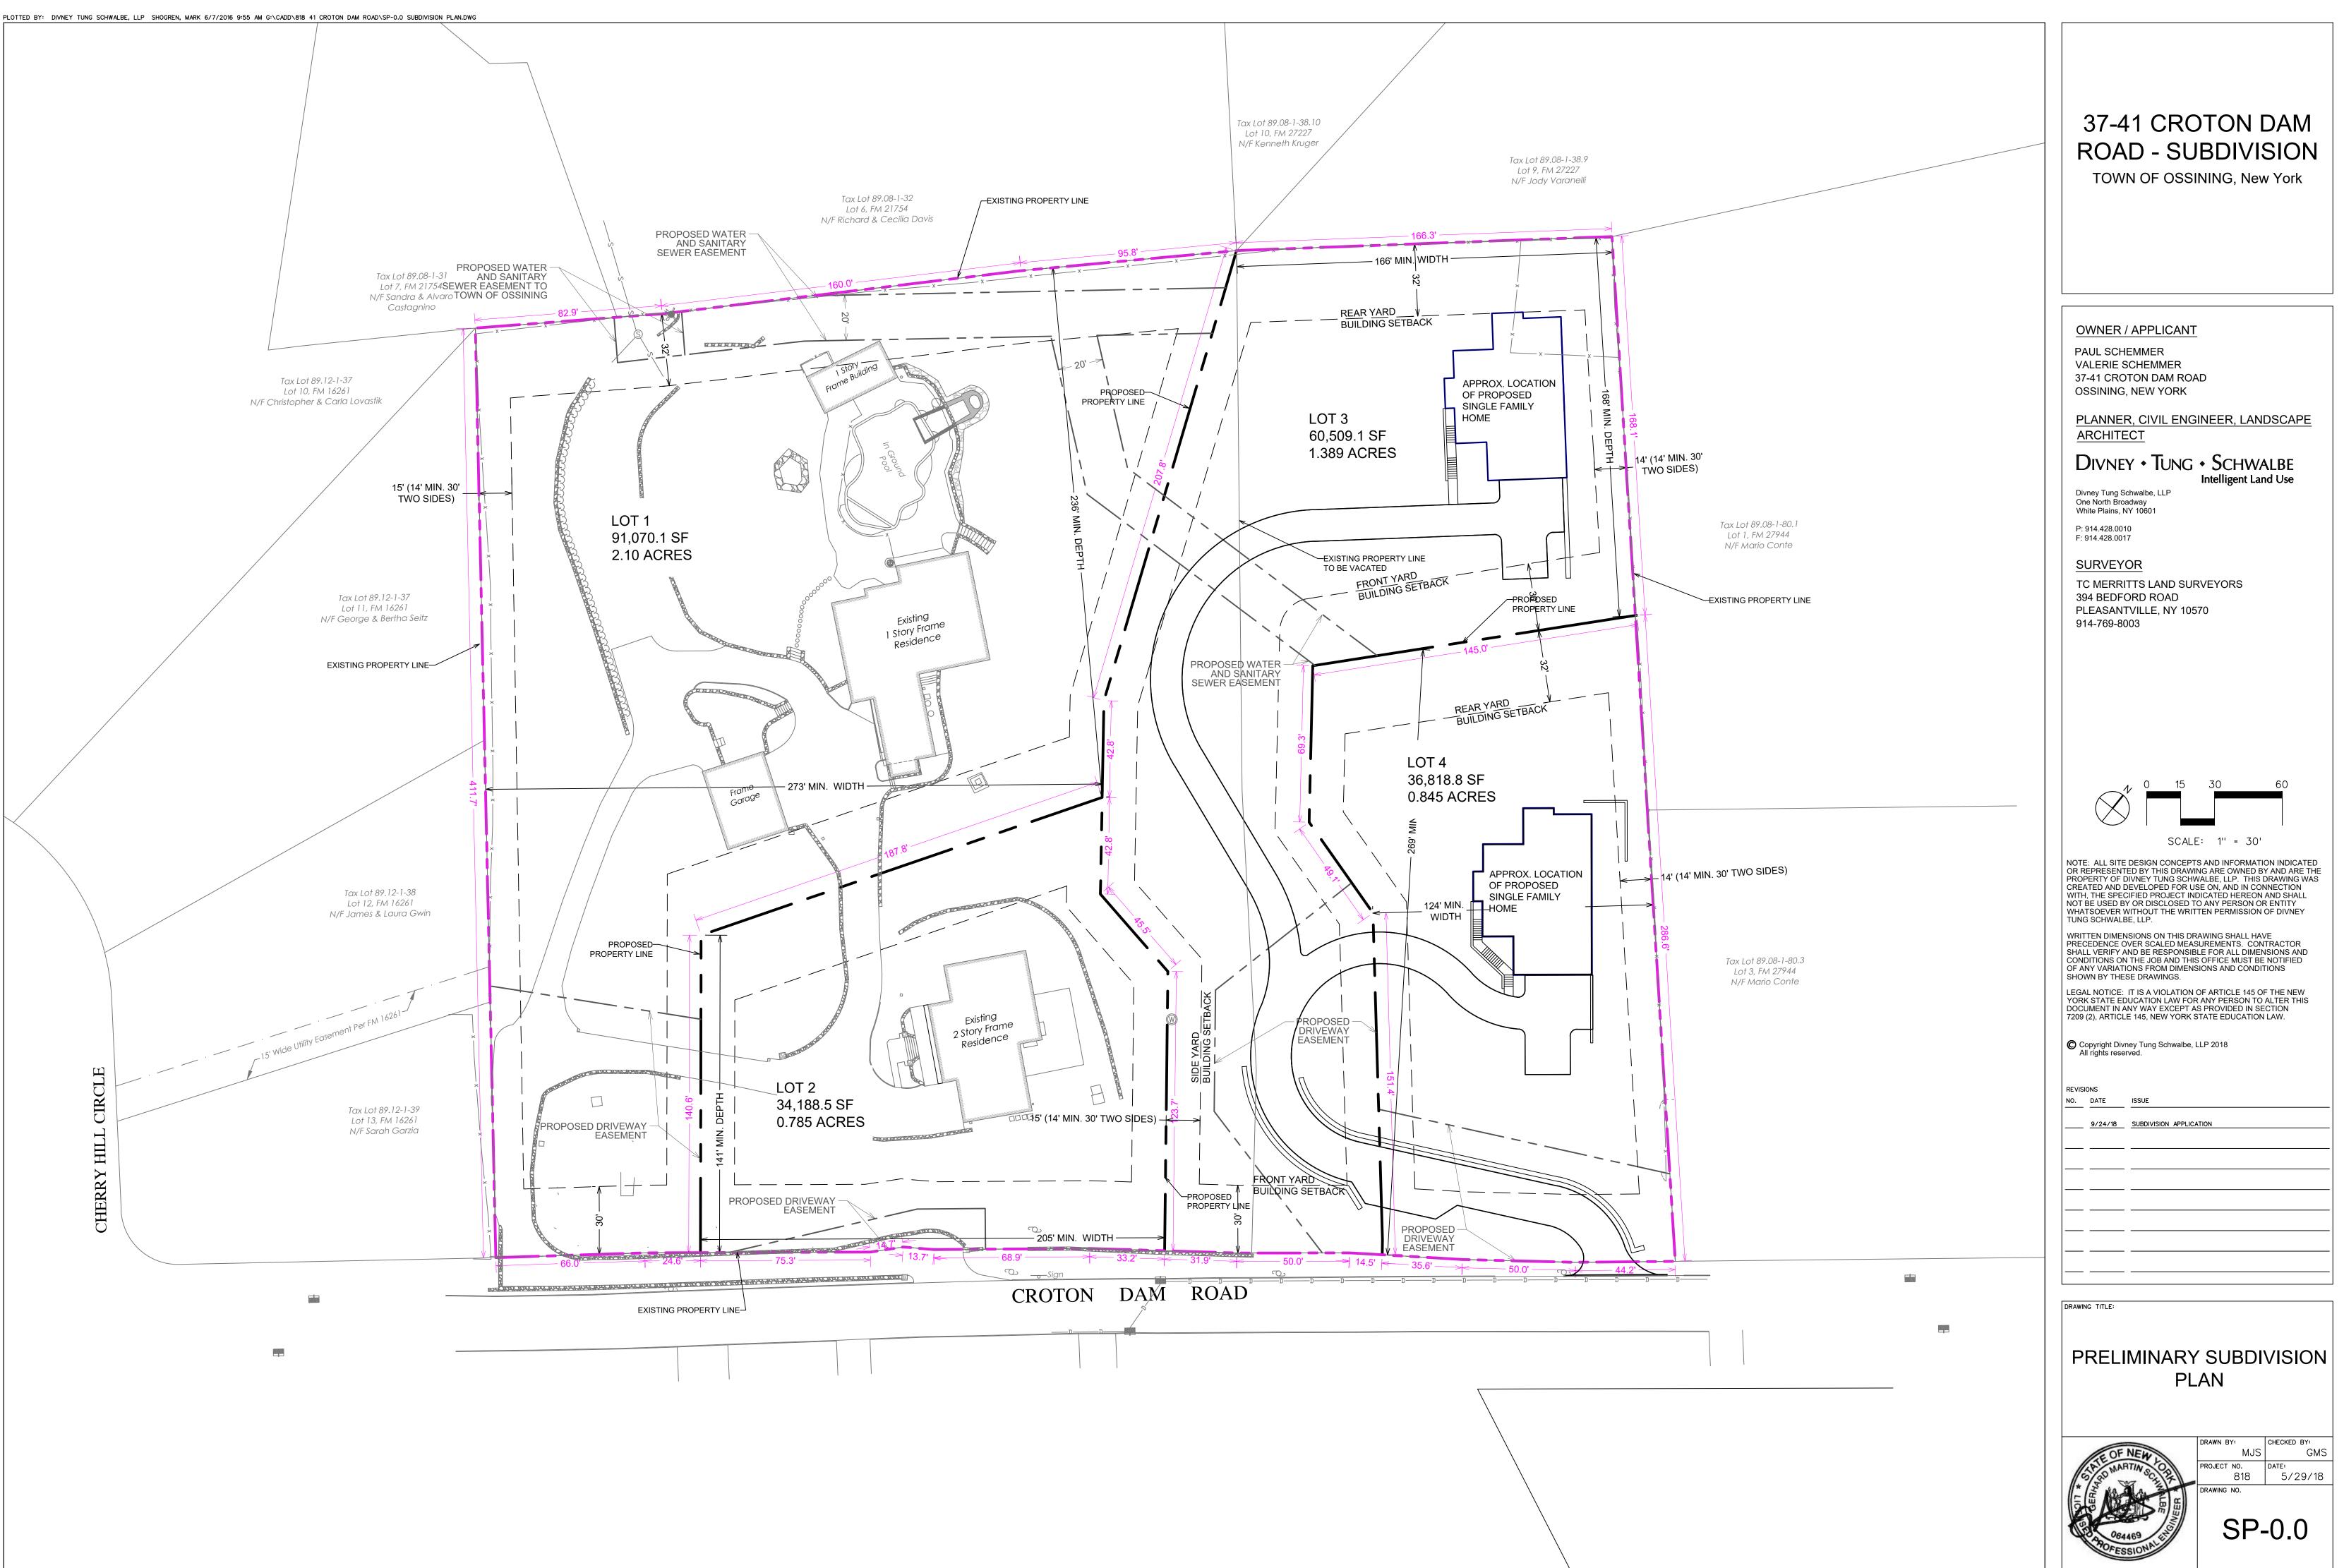




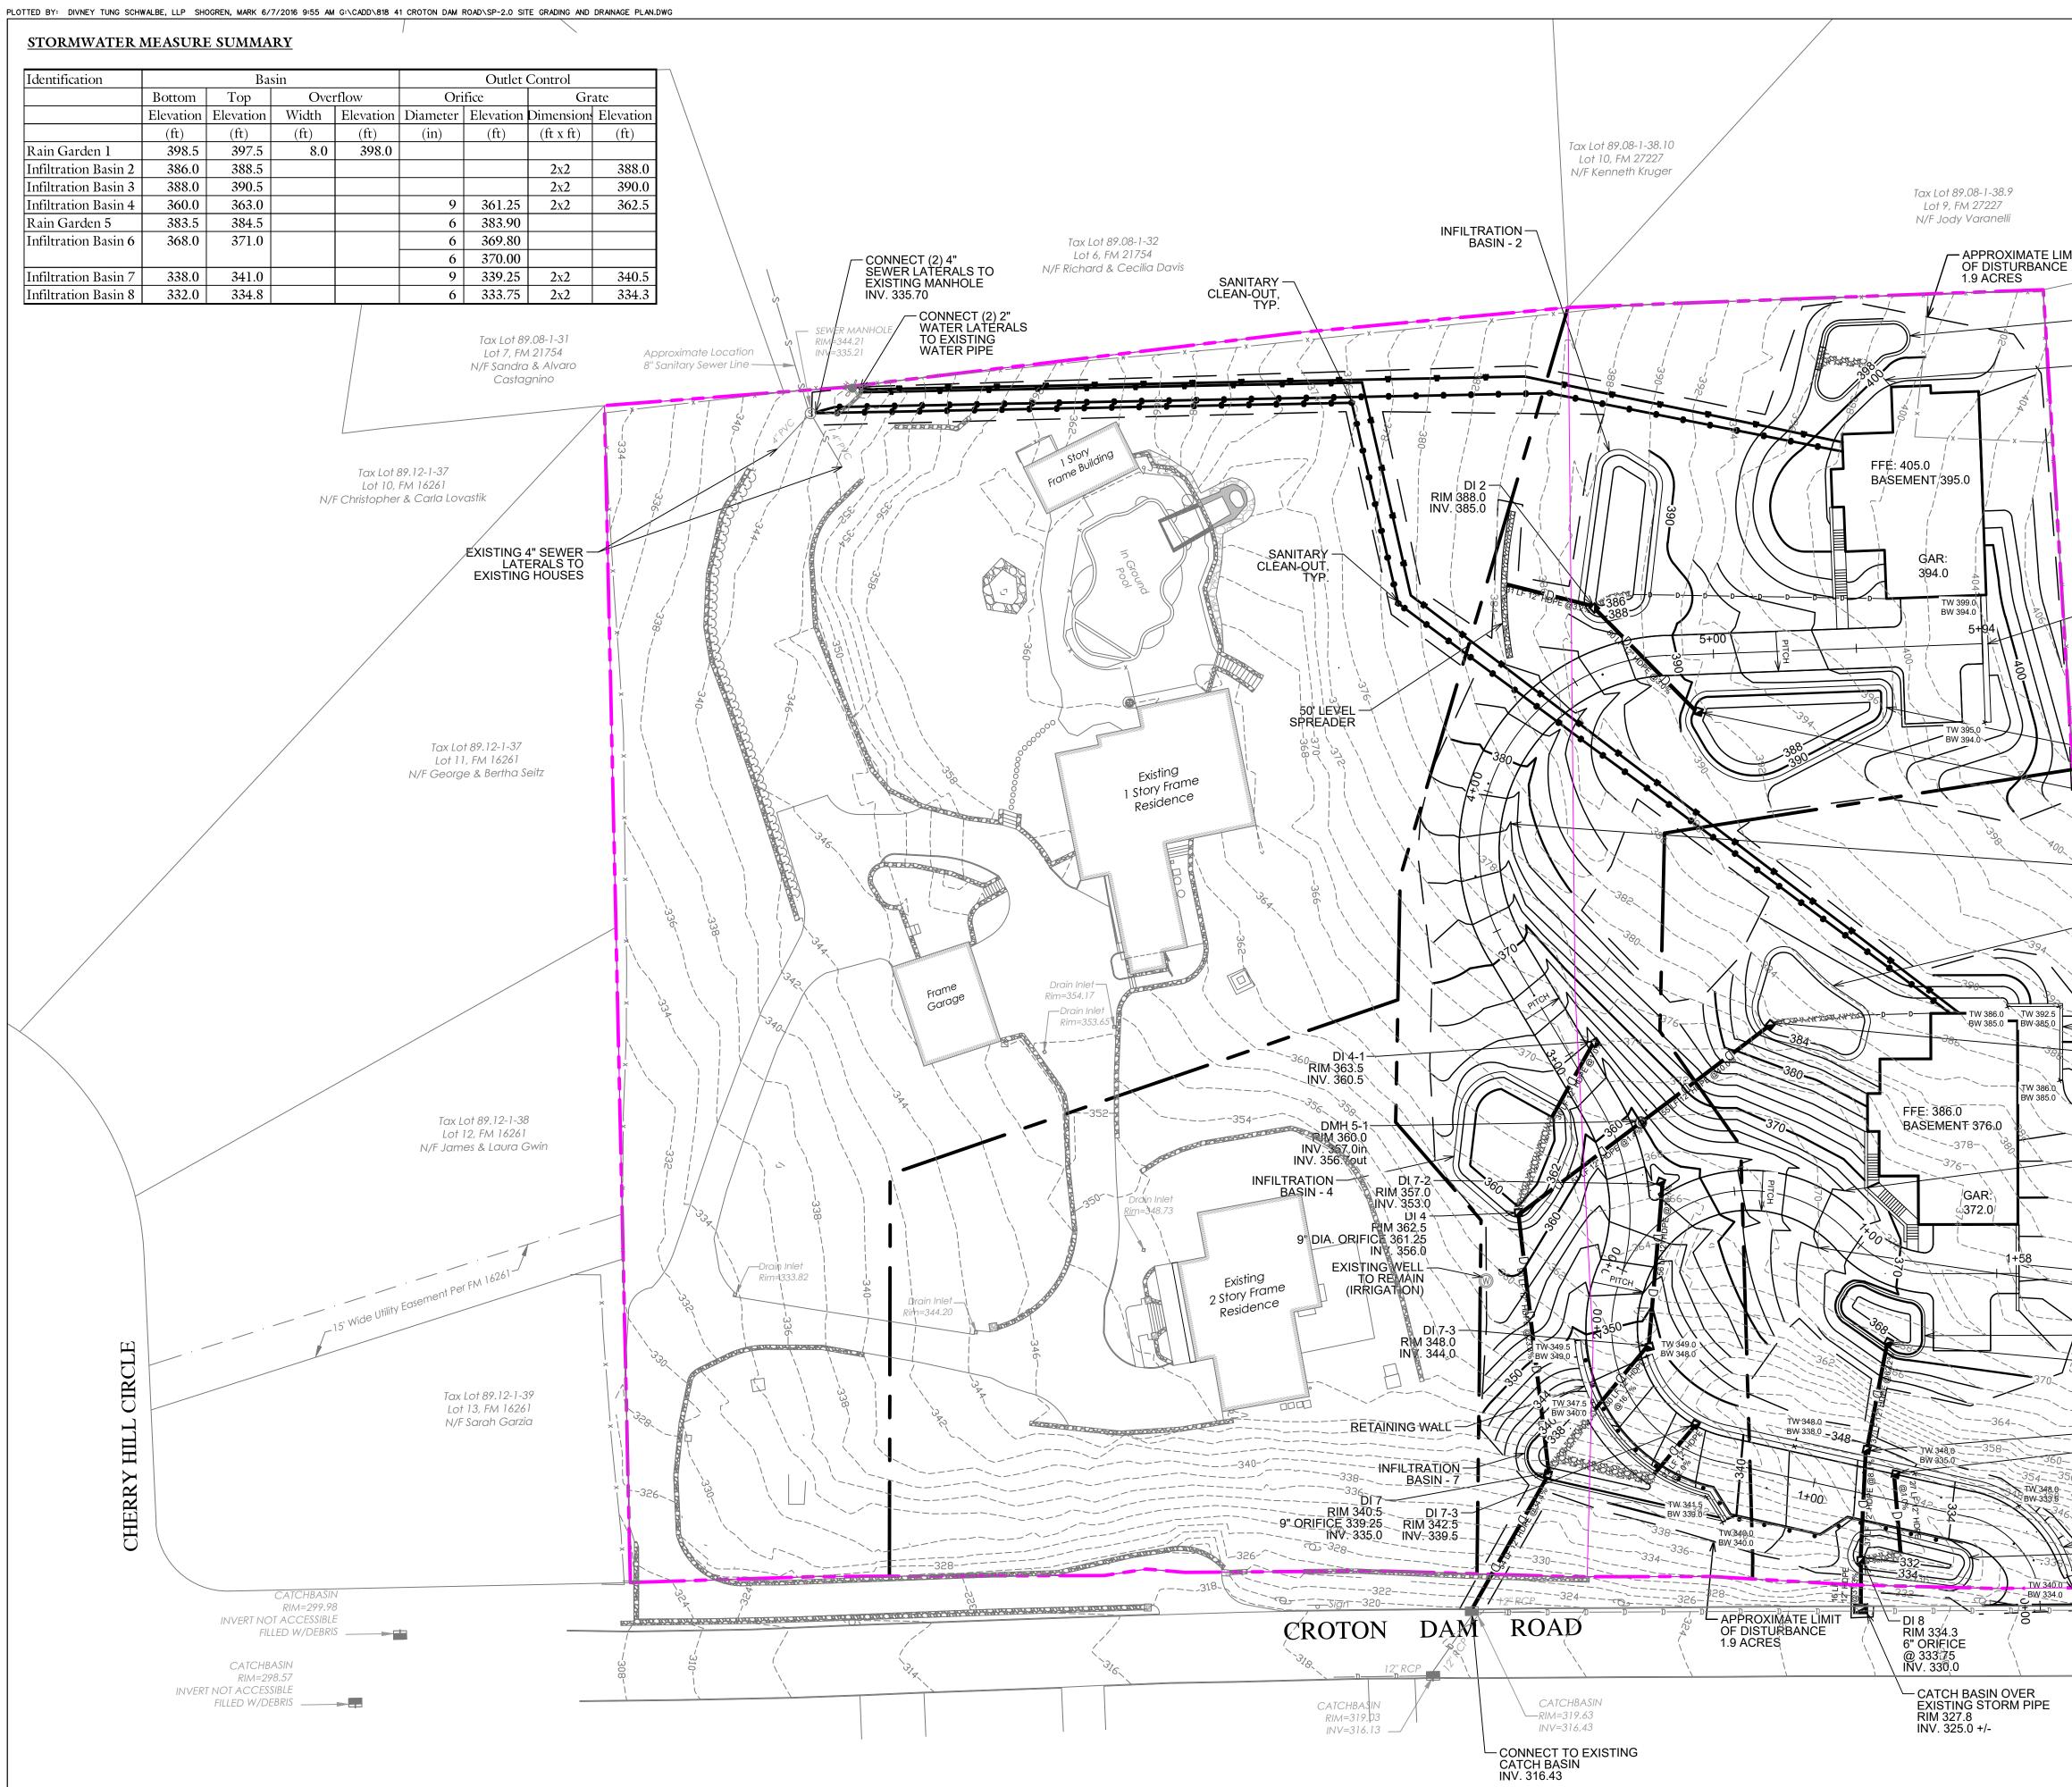


MIT		37-41 CROTON DAM ROAD - SUBDIVISION TOWN OF OSSINING, New York
	AIN GARDEN -1	
6 Ll	" PVC ROOF EADER	
		OWNER / APPLICANT PAUL SCHEMMER VALERIE SCHEMMER 37-41 CROTON DAM ROAD OSSINING, NEW YORK PLANNER, CIVIL ENGINEER, LANDSCAPE
		ARCHITECT
R	RETAINING WALL	DIVNEY • TUNG • SCHWALBE Intelligent Land Use
< .	Tax Lot 89.08-1-80.1 Lot 1, FM 27944	One North Broadway White Plains, NY 10601 P: 914.428.0010 F: 914.428.0017
X	N/F Mario Conte	SURVEYOR
	NFILTRATION BASIN - 3	TC MERRITTS LAND SURVEYORS 394 BEDFORD ROAD PLEASANTVILLE, NY 10570 914-769-8003
、 R	01 3 RIM 390.0 NV. 386.5	
	GRASS GWALE	
R	RAIN GARDEN - 5	
	APPROXIMATE LIMIT DF DISTURBANCE .9 ACRES	↓ 0 15 30 60
<r< th=""><th>RETAINING WALL</th><th>SCALE: 1" = 30'</th></r<>	RETAINING WALL	SCALE: 1" = 30'
R 6	RIM 385.0 S" ORIFICE 383.9 NV. 379.0	NOTE: ALL SITE DESIGN CONCEPTS AND INFORMATION INDICATED OR REPRESENTED BY THIS DRAWING ARE OWNED BY AND ARE THE PROPERTY OF DIVNEY TUNG SCHWALBE, LLP. THIS DRAWING WAS CREATED AND DEVELOPED FOR USE ON, AND IN CONNECTION WITH, THE SPECIFIED PROJECT INDICATED HEREON AND SHALL
	GRASS SWALE	NOT BE USED BY OR DISCLOSED TO ANY PERSON OR ENTITY WHATSOEVER WITHOUT THE WRITTEN PERMISSION OF DIVNEY TUNG SCHWALBE, LLP. WRITTEN DIMENSIONS ON THIS DRAWING SHALL HAVE
*	Tax Lot 89.08-1-80.3 Lot 3, FM 27944 N/F Mario Conte	PRECEDENCE OVER SCALED MEASUREMENTS. CONTRACTOR SHALL VERIFY AND BE RESPONSIBLE FOR ALL DIMENSIONS AND CONDITIONS ON THE JOB AND THIS OFFICE MUST BE NOTIFIED OF ANY VARIATIONS FROM DIMENSIONS AND CONDITIONS SHOWN BY THESE DRAWINGS. LEGAL NOTICE: IT IS A VIOLATION OF ARTICLE 145 OF THE NEW
	RETAINING WALL GRASS	YORK STATE EDUCATION LAW FOR ANY PERSON TO ALTER THIS DOCUMENT IN ANY WAY EXCEPT AS PROVIDED IN SECTION 7209 (2), ARTICLE 145, NEW YORK STATE EDUCATION LAW.
<u></u>	SWALE NFILTRATION BASIN - 6	Copyright Divney Tung Schwalbe, LLP 2018 All rights reserved.
	DI 6 RIM 371.0 6" ORIFICE 369.8 6" ORIFICE 370.0	REVISIONS NO. DATE ISSUE
	NV. 367.0 ————————————————————————————————————	9/24/18 SUBDIVISION APPLICATION
F R	NV. 332.3 INV. 333.0out	
TW 339.0	- INFILTRATION BASIN - 8 CATCHBASIN - RIM=343.42 INVERT NOT ACCESSIBLE	
	FILLED W/DEBRIS	DRAWING TITLE:
	INVERT NOT ACCESSIBLE FILLED W/DEBRIS	
		SITE ENGINEERING PLAN
		DRAWN BY: CHECKED BY:
		MJS GMS GRAD MARTIN SCIENT PROJECT NO. DATE: 818 5/29/18
		DRAWING NO. 064469 SP-2.0
		ression



	37-41 CROTON DAM
	ROAD - SUBDIVISION TOWN OF OSSINING, New York
IMIT	TOWIN OF OSSIMING, New TOR
E	
	<u>OWNER / APPLICANT</u>
PROPOSED EVERGREEN TREE, TYP.	PAUL SCHEMMER VALERIE SCHEMMER
PROPOSED ORNAMENTAL TREE, TYP.	37-41 CROTON DAM ROAD OSSINING, NEW YORK
PROPOSED SHADE TREE, TYP.	PLANNER, CIVIL ENGINEER, LANDSCAPE ARCHITECT
EXISTING TREE TO BE REMOVED, TYP.	DIVNEY + TUNG + SCHWALBE
EXISTING TREE TO REMAIN, TYP.	Intelligent Land Use Divney Tung Schwalbe, LLP One North Broadway
Tax Lot 89.08-1-80.1 Lot 1, FM 27944	White Plains, NY 10601 P: 914.428.0010 F: 914.428.0017
N/F Mario Conte	SURVEYOR
	TC MERRITTS LAND SURVEYORS 394 BEDFORD ROAD DI FASANITIVILI F. NY 10570
	PLEASANTVILLE, NY 10570 914-769-8003
to service a ser	
APPROXIMATE LIMIT OF DISTURBANCE 1.9 ACRES	
	SCALE: 1" = 30'
	NOTE: ALL SITE DESIGN CONCEPTS AND INFORMATION INDICATED OR REPRESENTED BY THIS DRAWING ARE OWNED BY AND ARE THE PROPERTY OF DIVNEY TUNG SCHWALBE, LLP. THIS DRAWING WAS
	CREATED AND DEVELOPED FOR USE ON, AND IN CONNECTION WITH, THE SPECIFIED PROJECT INDICATED HEREON AND SHALL NOT BE USED BY OR DISCLOSED TO ANY PERSON OR ENTITY WHATSOEVER WITHOUT THE WRITTEN PERMISSION OF DIVNEY
	TUNG SCHWALBE, LLP. WRITTEN DIMENSIONS ON THIS DRAWING SHALL HAVE PRECEDENCE OVER SCALED MEASUREMENTS. CONTRACTOR
Tax Lot 89.08-1-80.3 Lot 3, FM 27944 N/F Mario Conte	SHALL VERIFY AND BE RESPONSIBLE FOR ALL DIMENSIONS AND CONDITIONS ON THE JOB AND THIS OFFICE MUST BE NOTIFIED OF ANY VARIATIONS FROM DIMENSIONS AND CONDITIONS SHOWN BY THESE DRAWINGS.
EXISTING TREE TO BE	LEGAL NOTICE: IT IS A VIOLATION OF ARTICLE 145 OF THE NEW YORK STATE EDUCATION LAW FOR ANY PERSON TO ALTER THIS DOCUMENT IN ANY WAY EXCEPT AS PROVIDED IN SECTION 7209 (2), ARTICLE 145, NEW YORK STATE EDUCATION LAW.
REMOVED, TYP.	Copyright Divney Tung Schwalbe, LLP 2018
PROPOSED EVERGREEN TREE, TYP.	All rights reserved.
PROPOSED ORNAMENTAL TREE, TYP.	REVISIONS NO. DATE ISSUE
PROPOSED SHADE TREE, TYP.	9/24/18SUBDIVISION APPLICATION
EXISTING TREE TO REMAIN, TYP.	
SIGHT STOPPING DISTANCE = 400'	
	DRAWING TITLE:
	LANDSCAPE PLAN
PLAN SHALL BE MAINTAINED IN A HEALTHY AND	DRAWN BY: CHECKED BY: SBK GMS
THROUGHOUT THE DURATION OF THE PROPOSED	PROJECT NO. DATE: 818 5/29/18 DRAWING NO.
NOT SO MAINTAINED SHALL BE REPLACED WITH T THE BEGINNING OF THE NEXT GROWING	SP-3.1
	PROFESSIONALE OF -5.1

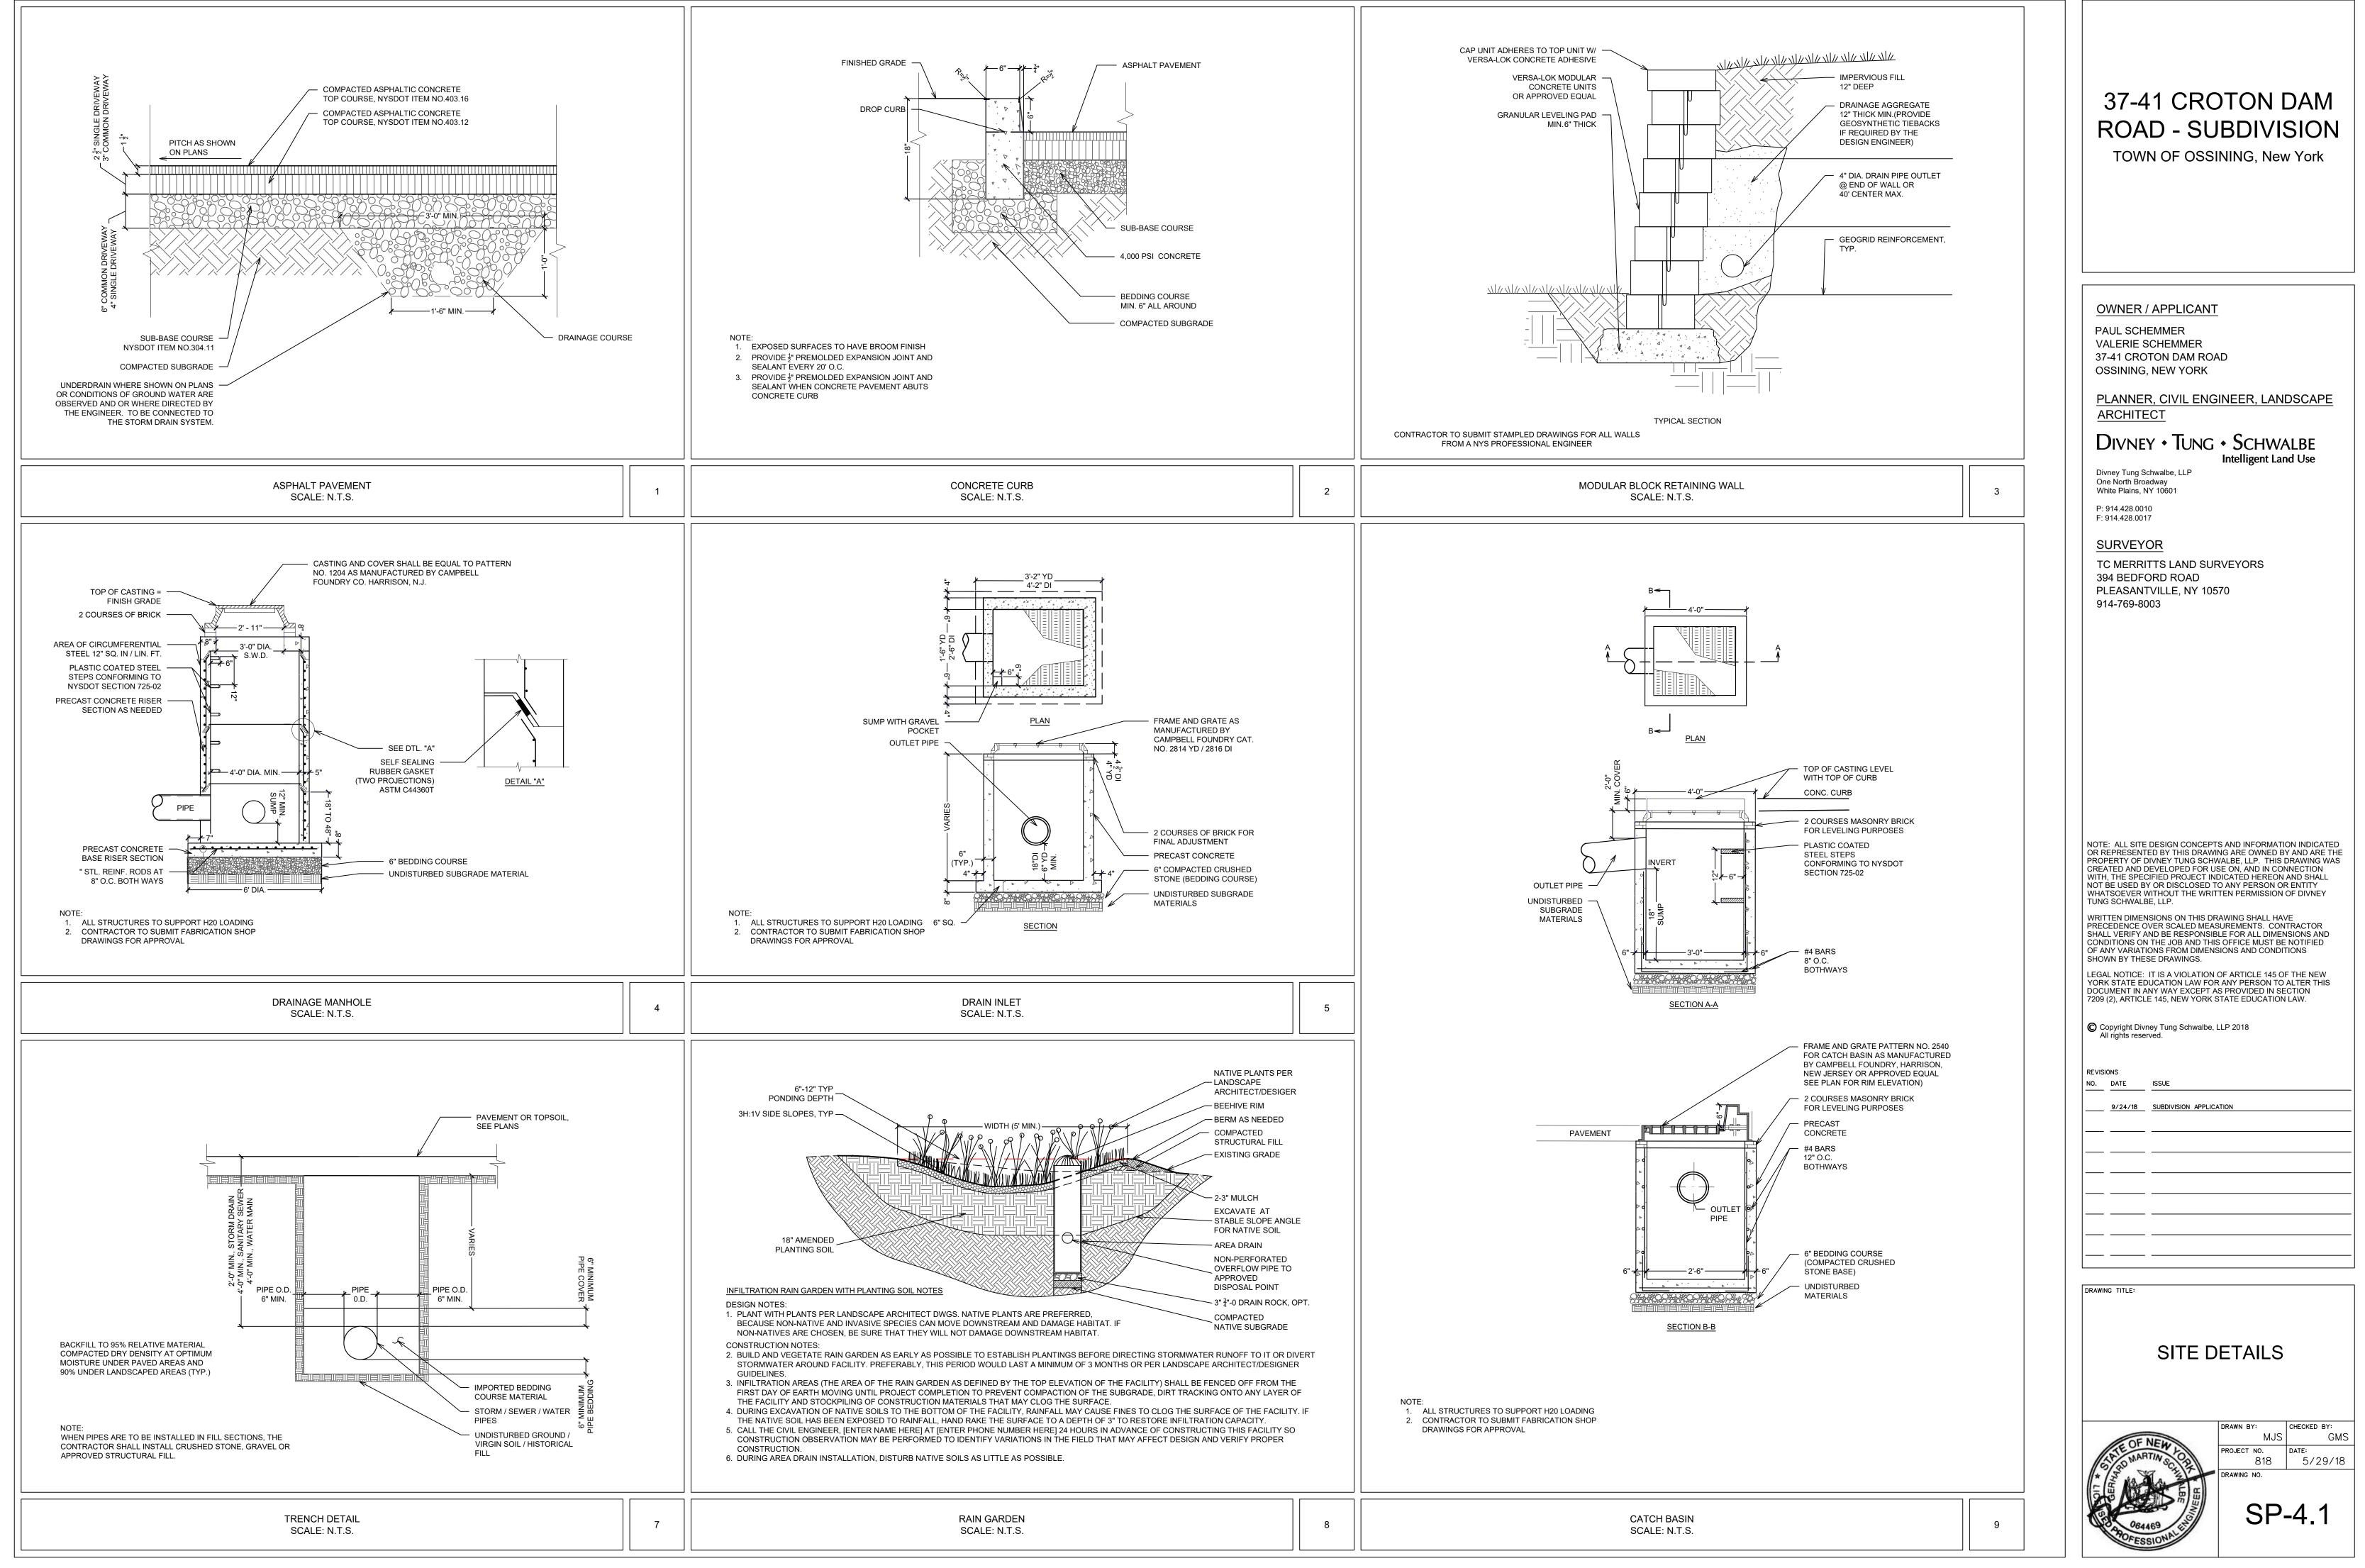




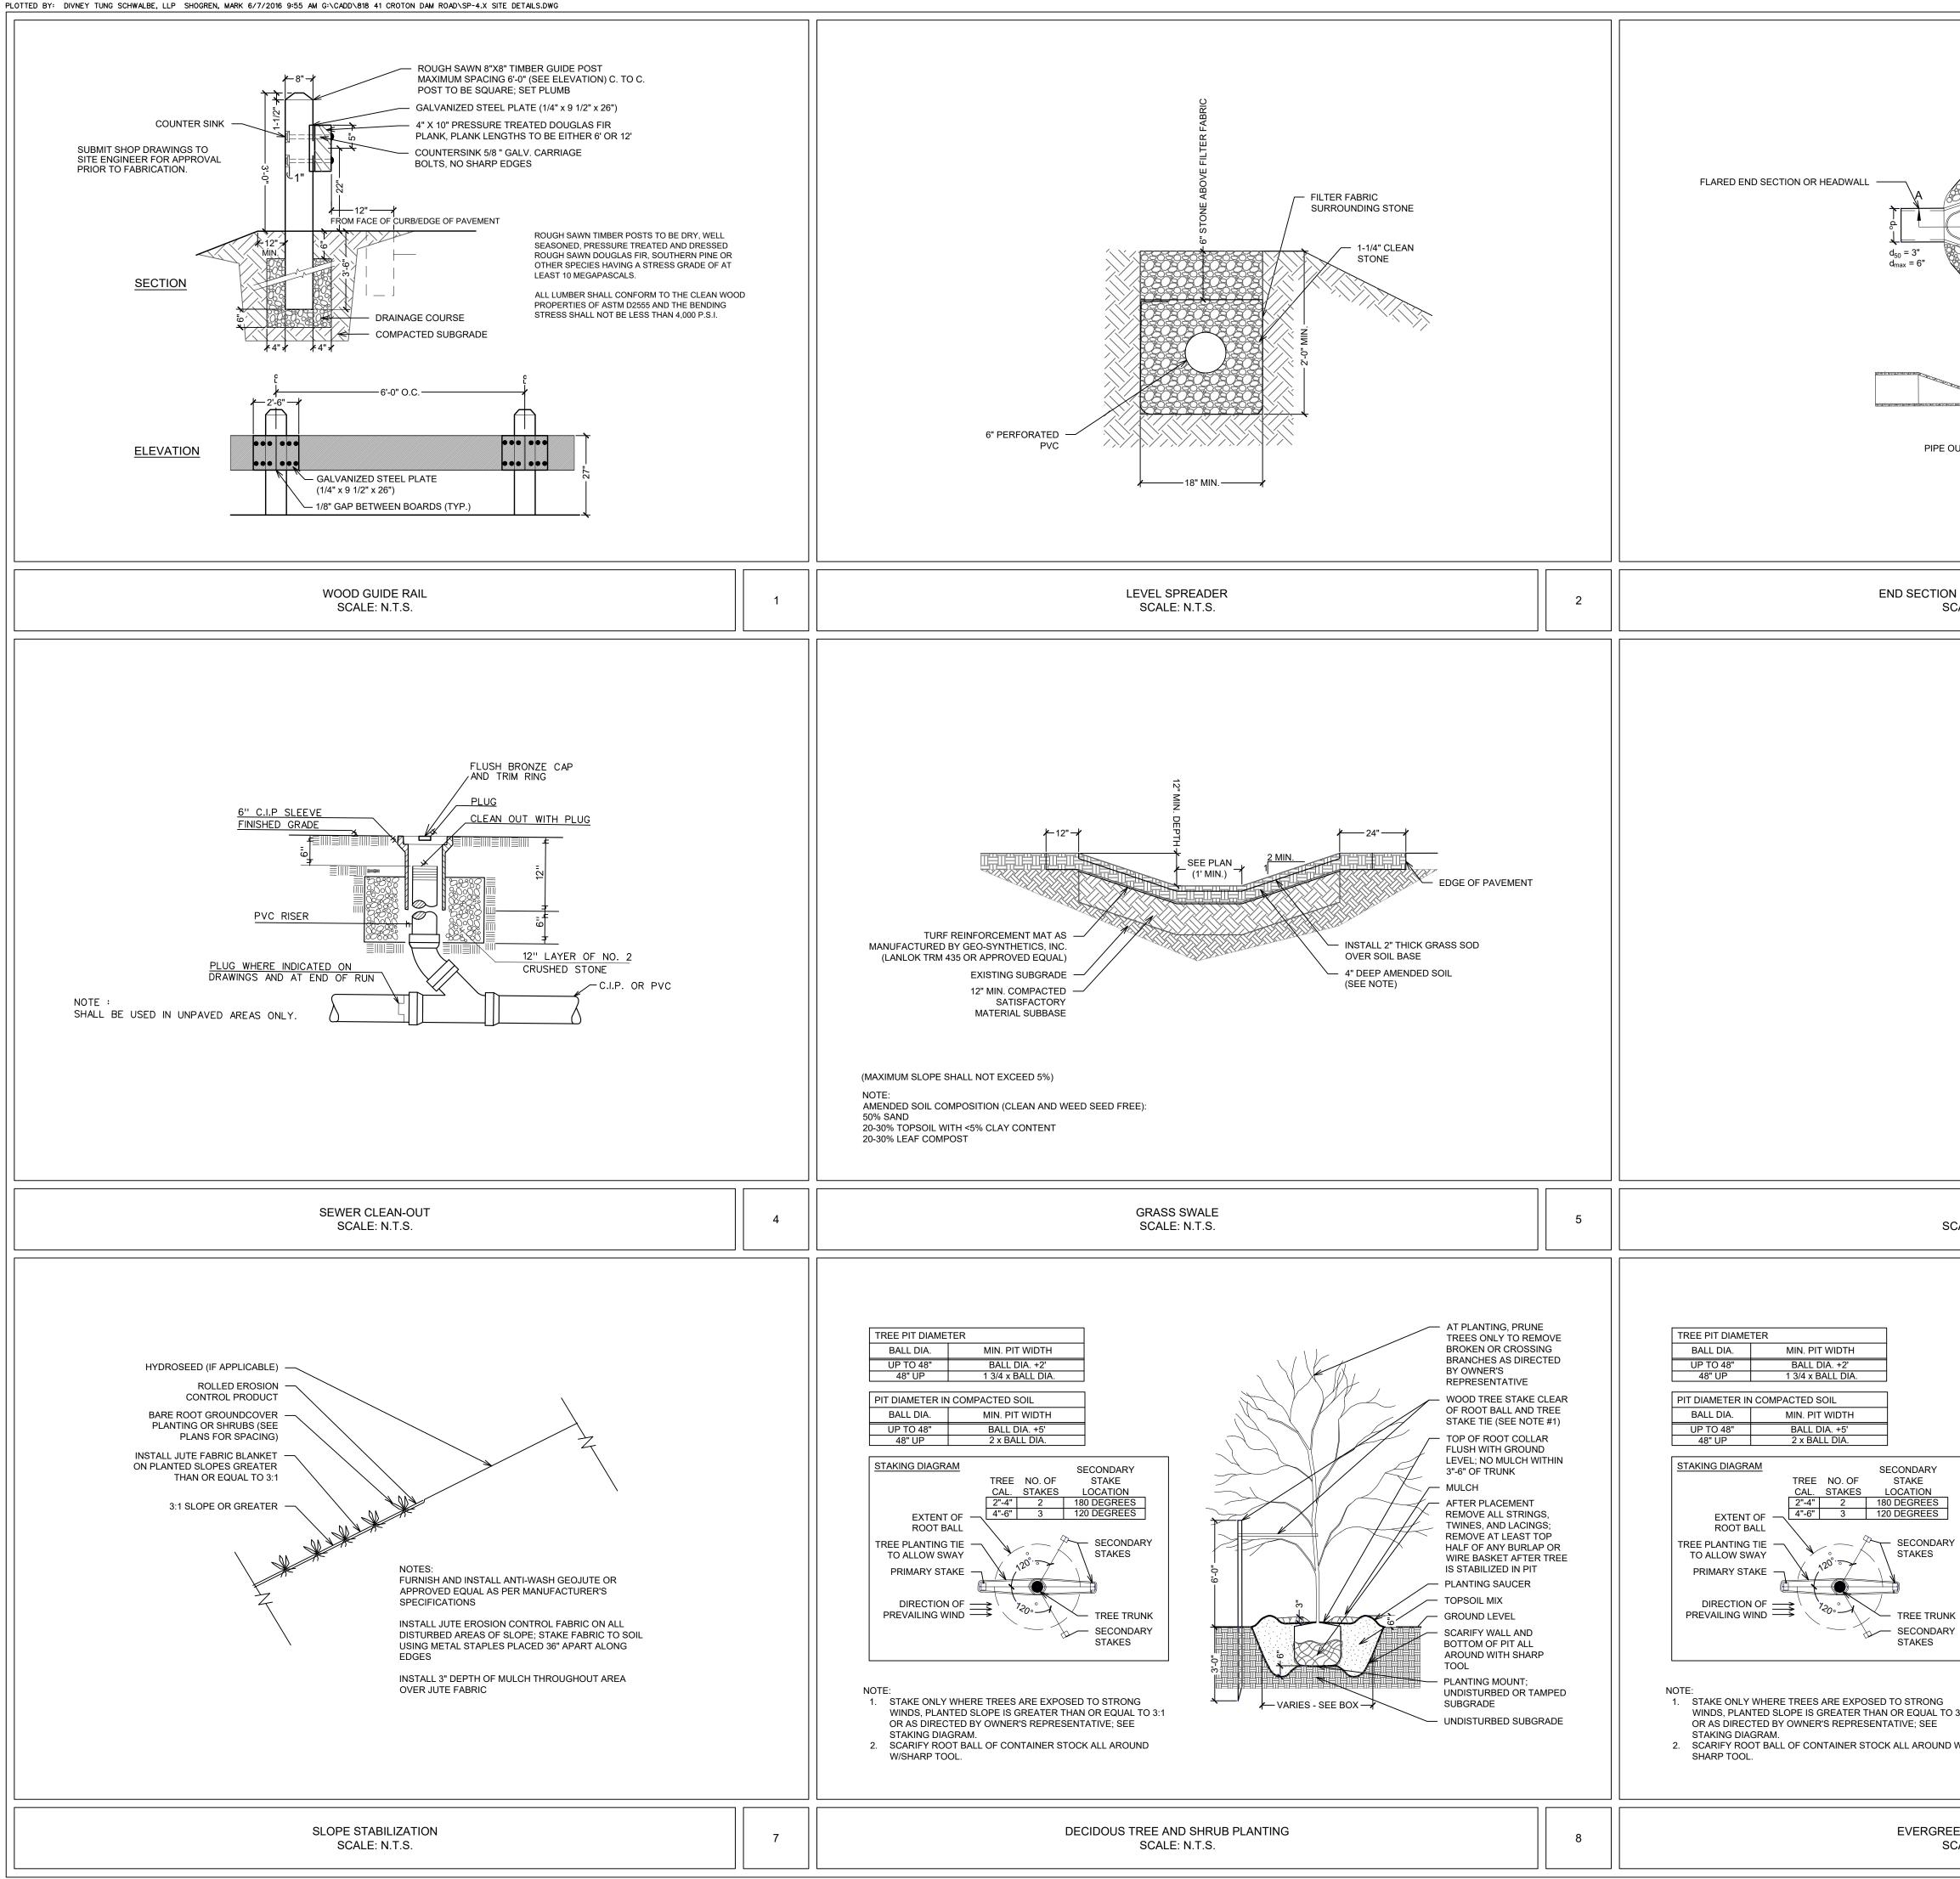


3'-0" OR TOP OF PIPE CHANNEL A 9" DEEP TRAP ROCK APRON		37-41 CRC ROAD - SU TOWN OF OSSI	
9" DEEP TRAP ROCK APRON PLAN PLAN 14' OR AS SHOWN ON PLANS SECTION A-A PIPE OUTLET TO WELL-DEFINED CHANNEL		OWNER / APPLICANT PAUL SCHEMMER VALERIE SCHEMMER 37-41 CROTON DAM ROA OSSINING, NEW YORK PLANNER, CIVIL ENG ARCHITECT DIVNEY • TUNG	AD INEER, LANDSCAPE
TION ENERGY DISSIPATOR SCALE: N.T.S.	3	Divney Tung Schwalbe, LLP One North Broadway White Plains, NY 10601 P: 914.428.0010 F: 914.428.0017 SURVEYOR TC MERRITTS LAND SUF 394 BEDFORD ROAD PLEASANTVILLE, NY 105 914-769-8003	RVEYORS
DETAIL SCALE: N.T.S.	6	NOTE: ALL SITE DESIGN CONCEPT OR REPRESENTED BY THIS DRAWI PROPERTY OF DIVNEY TUNG SCHV CREATED AND DEVELOPED FOR US WITH, THE SPECIFIED PROJECT INI NOT BE USED BY OR DISCLOSED T WHATSOEVER WITHOUT THE WRIT TUNG SCHWALBE, LLP. WRITTEN DIMENSIONS ON THIS DR PRECEDENCE OVER SCALED MEAS SHALL VERIFY AND BE RESPONSIB CONDITIONS ON THE JOB AND THIS OF ANY VARIATIONS FROM DIMENS SHOWN BY THESE DRAWINGS. LEGAL NOTICE: IT IS A VIOLATION I YORK STATE EDUCATION LAW FOR DOCUMENT IN ANY WAY EXCEPT A 7209 (2), ARTICLE 145, NEW YORK S	NG ARE OWNED BY AND ARE THE VALBE, LLP. THIS DRAWING WAS SE ON, AND IN CONNECTION DICATED HEREON AND SHALL O ANY PERSON OR ENTITY TEN PERMISSION OF DIVNEY AWING SHALL HAVE SUREMENTS. CONTRACTOR LE FOR ALL DIMENSIONS AND S OFFICE MUST BE NOTIFIED SIONS AND CONDITIONS OF ARTICLE 145 OF THE NEW & ANY PERSON TO ALTER THIS S PROVIDED IN SECTION STATE EDUCATION LAW.
AT PLANTING, PRUNE TREES ONLY TO REMU BRANCHES AS DIRECT BY OWNERS REPRESENTATIVE WOOD TREE STAKE CL OF ROOT BALL AND TR STAKE TIE (SEE NOTE TOP OF ROOT COLLAR FLUSH WITH GROUND LEVEL; NO MULCH WITH GROUND LEVEL TOP OF ROOT COLLAR FLUSH WITH GROUND LEVEL NO MULCH WITH STAKE TIE (SEE NOTE TOP OF ROOT COLLAR FLUSH WITH GROUND LEVEL NO MULCH WITH STAKE TIE (SEE NOTE TOP OF ROOT COLLAR FLUSH WITH GROUND LEVEL NO MULCH WITH STAKE TIE (SEE NOTE TOP OF ROOT COLLAR FLUSH WITH GROUND LEVEL NO MULCH WITH STAKE TIE (SEE NOTE TOP OF ROOT COLLAR FLUSH WITH GROUND LEVEL TO PO OF ROOT COLLAR FLUSH WITH GROUND LEVEL TOP OF ROOT COLLAR MULCH AFTER PLACEMENT REMOVE ALL STRINGS WITE BASKET AFTER TH IS STABILIZED IN PIT ALL OF ANY BURLAP WIRE BASKET AFTER TH IS STABILIZED IN PIT ANTING SAUCER GROUND LEVEL TOP SOIL MIX SCARIFY WALL AND BOTTON FUT ALL AROUND WITH SHARP TOOL PLANTING MOUNT; UNDISTURBED SUBGR UNDISTURBED SUBGR UNDISTURBED SUBGR	G TED	REVISIONS ISSUE NO. DATE ISSUE 9/24/18 SUBDIVISION APPLICA	ATION ETAILS DRAWN BY: CHECKED BY: MJS GMS PROJECT NO. DATE: 818 5/29/18 DRAWING NO.
GREEN TREE PLANTING SCALE: N.T.S.	9	064469 E	SP-4.2


GMS



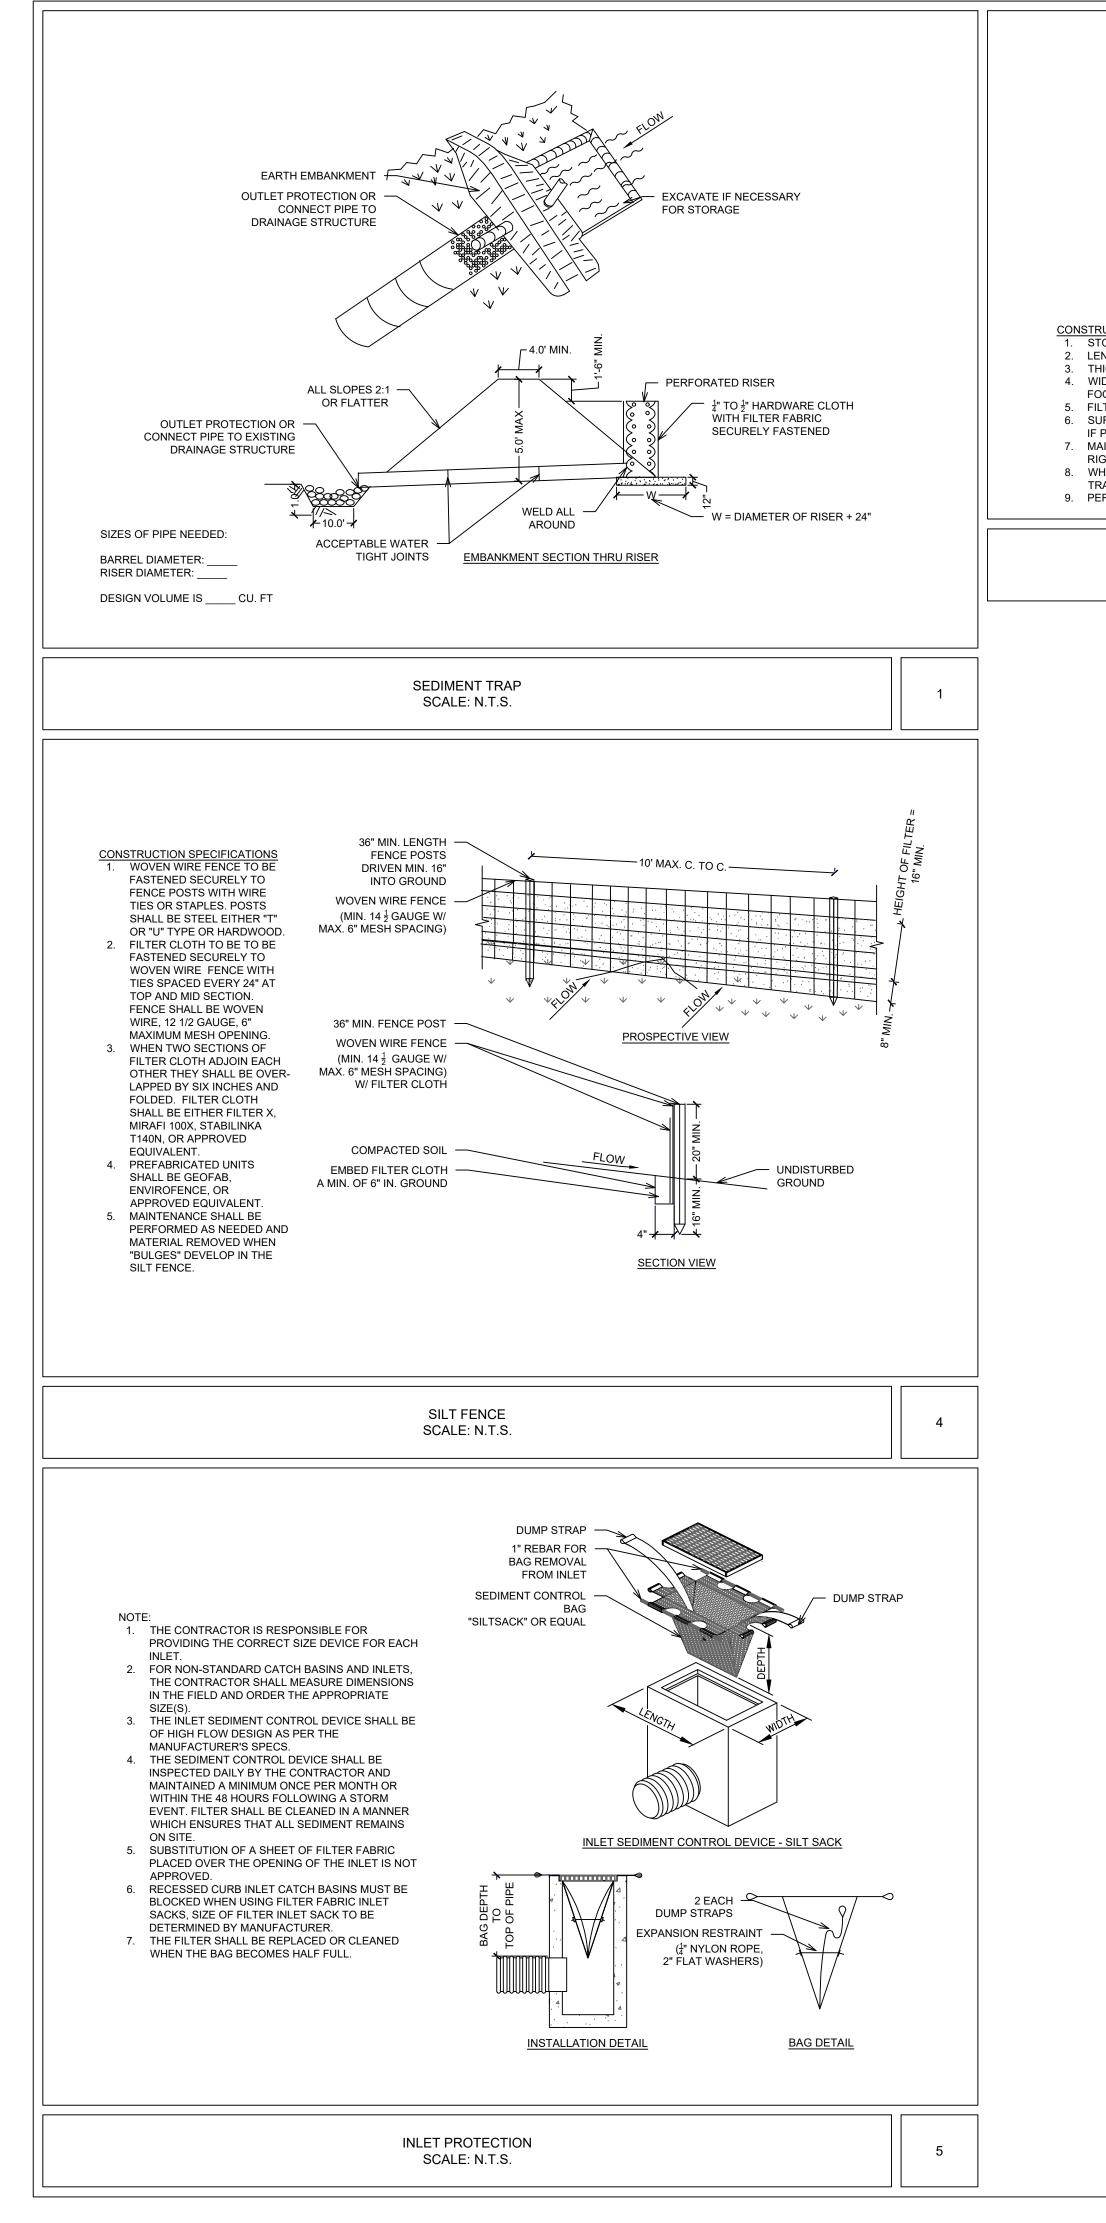


PLOTTED BY: DIVNEY TUNG SCHWALBE, LLP SHOGREN, MARK 6/7/2016 9:55 AM G:\CADD\818 41 CROTON DAM ROAD\SP-5.1 EROSION CONTROL PLAN AND DETAILS.DWG

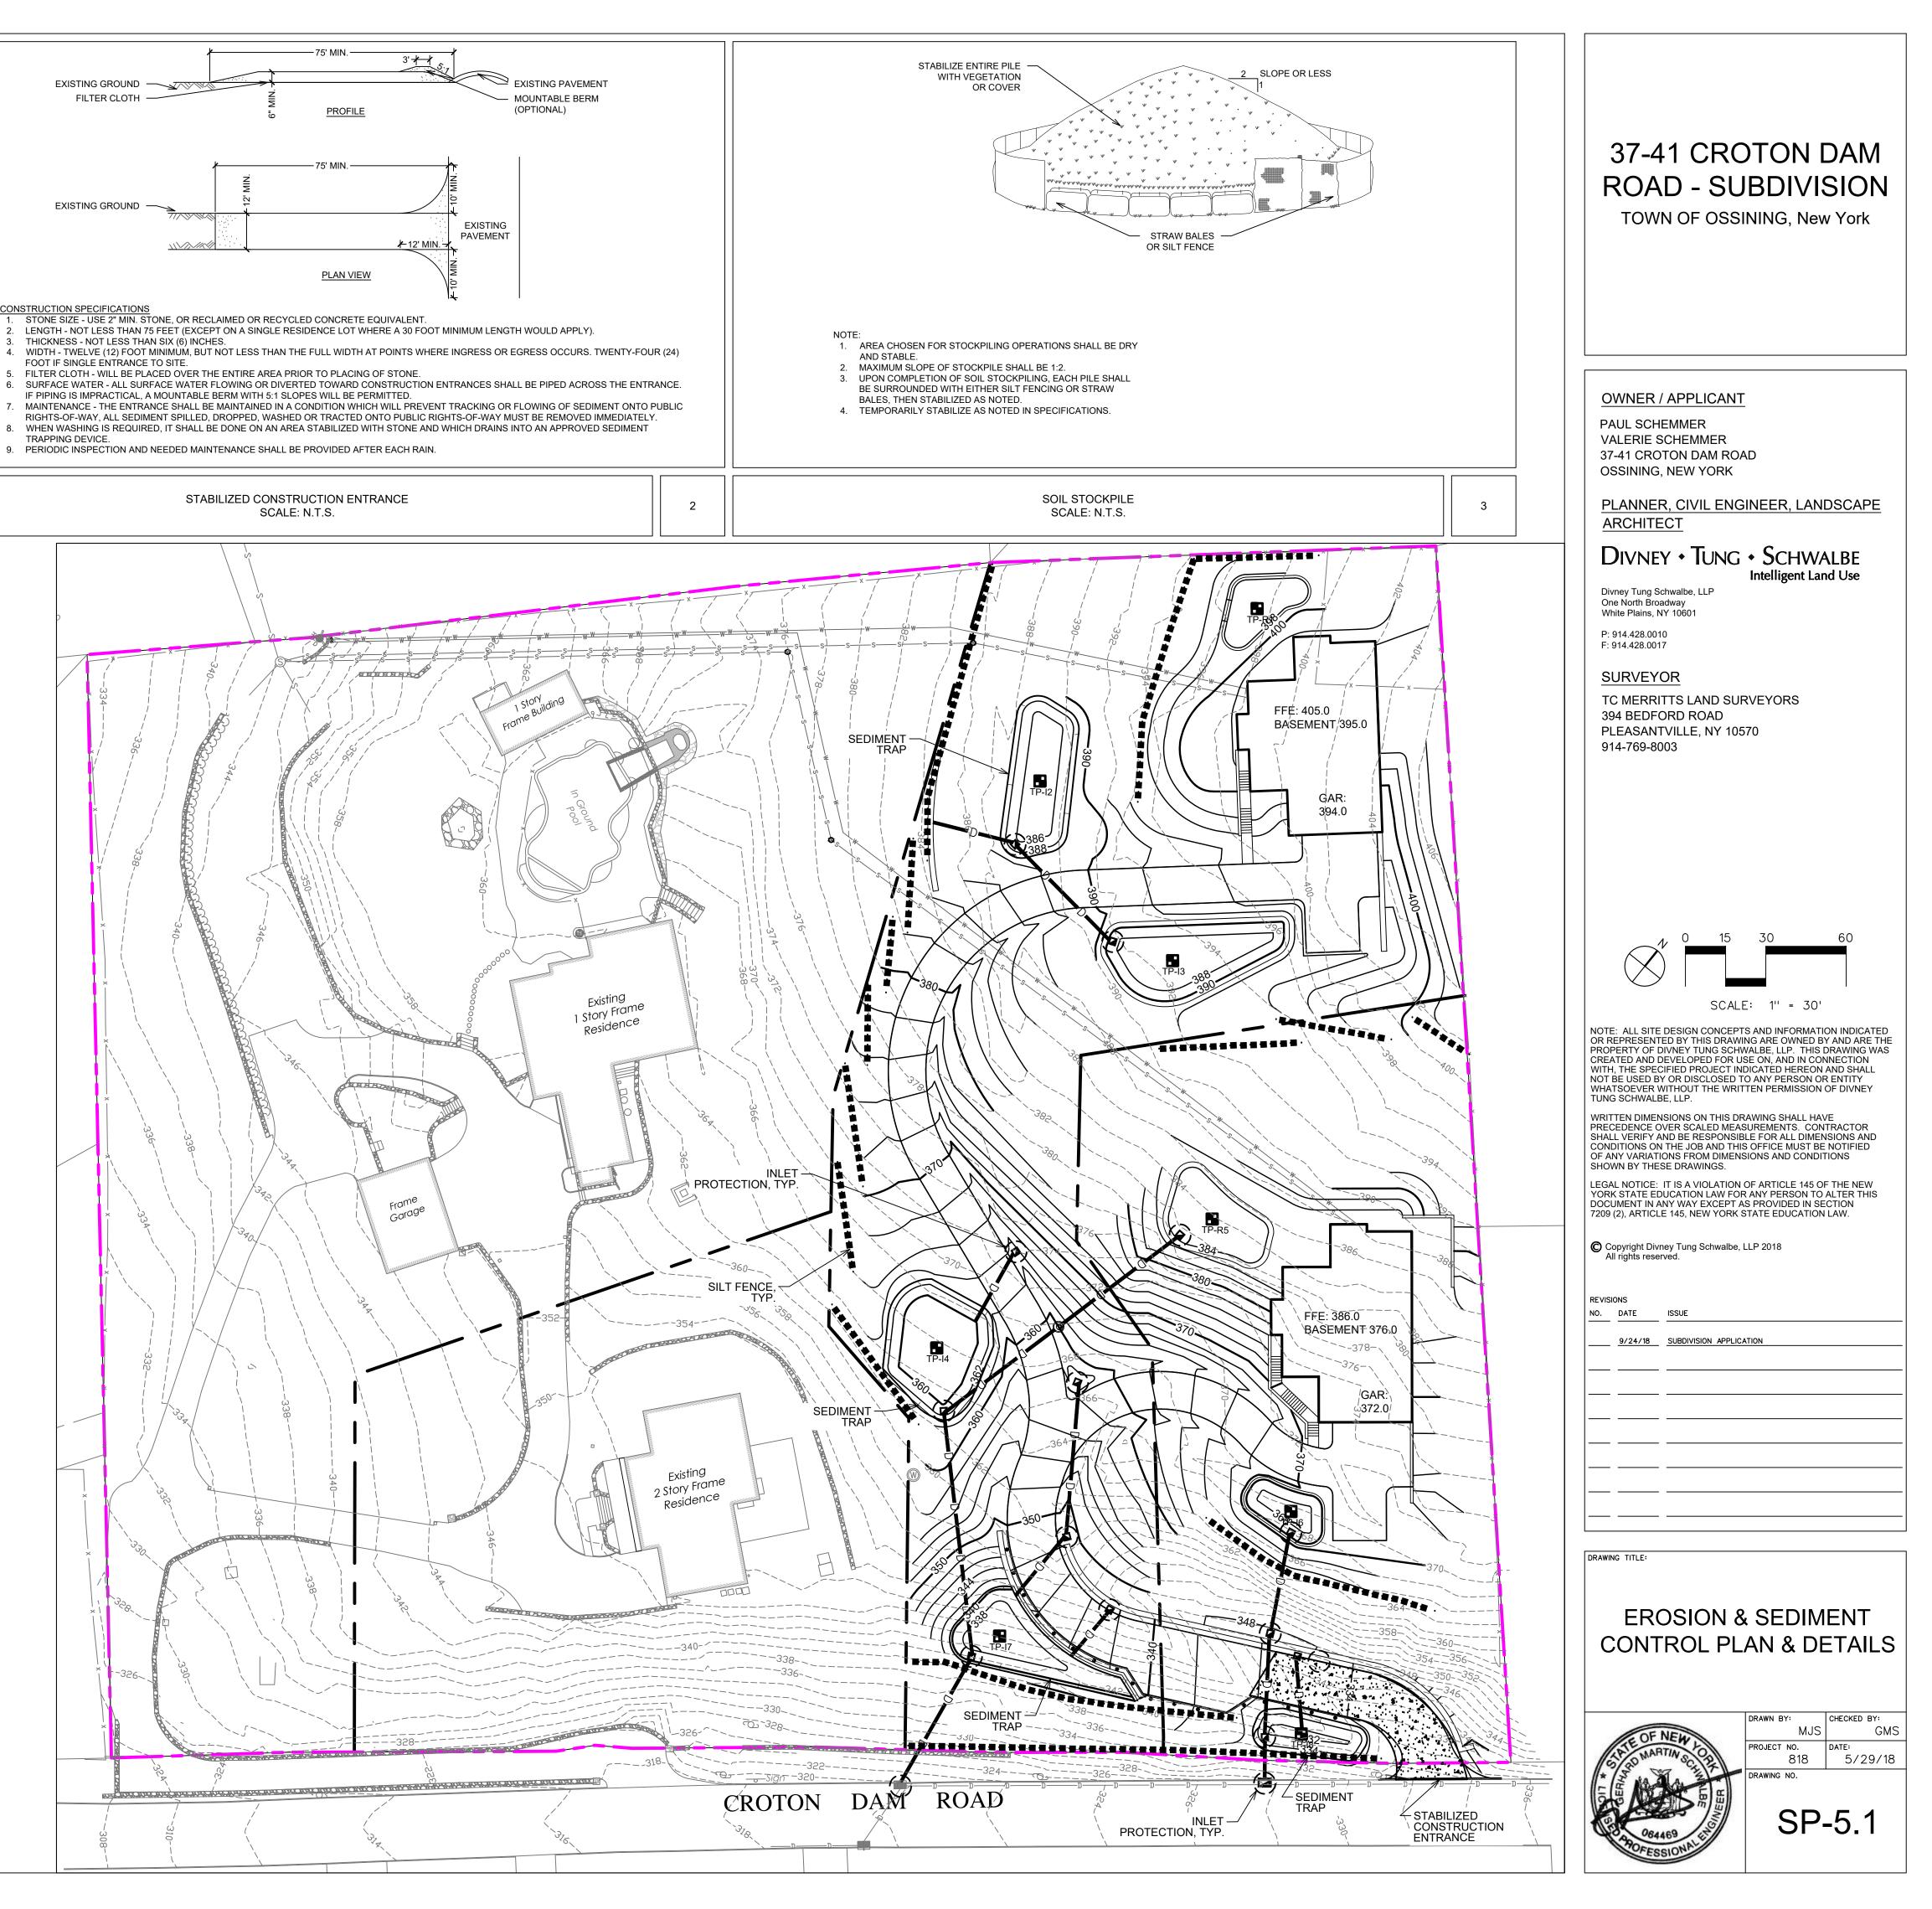

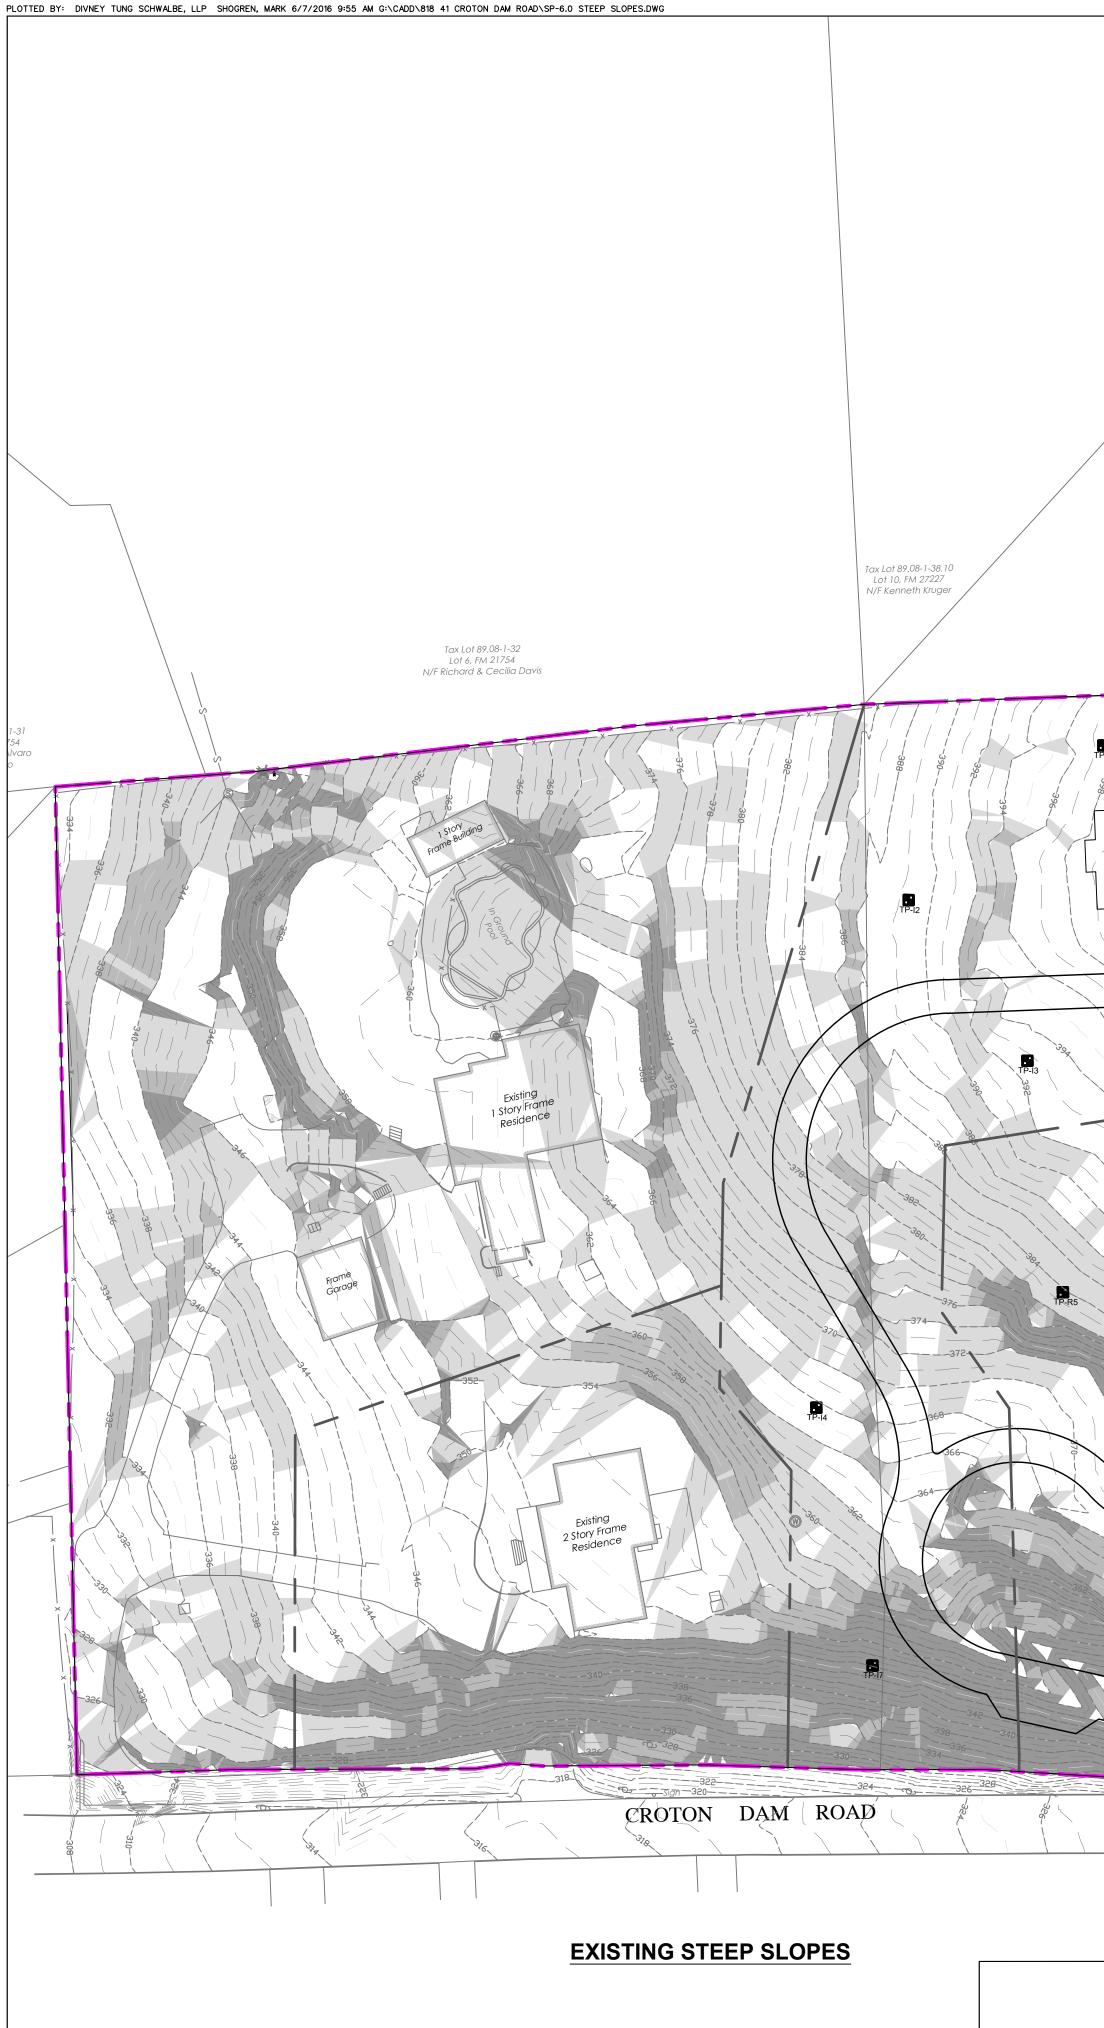

STEEP SLOPE 35.00% EXTREMLY STEEP SLOPE

Existing Slopes TableCLASSIFICATIONMinimum SlopeMaximum SlopeColorAREA (SF)MODERATELY STEEP SLOPE15.00%25.00%67,500VERY STEEP SLOPE25.00%35.00%21,500EXTREMLY STEEP SLOPE35.00%-31,000	

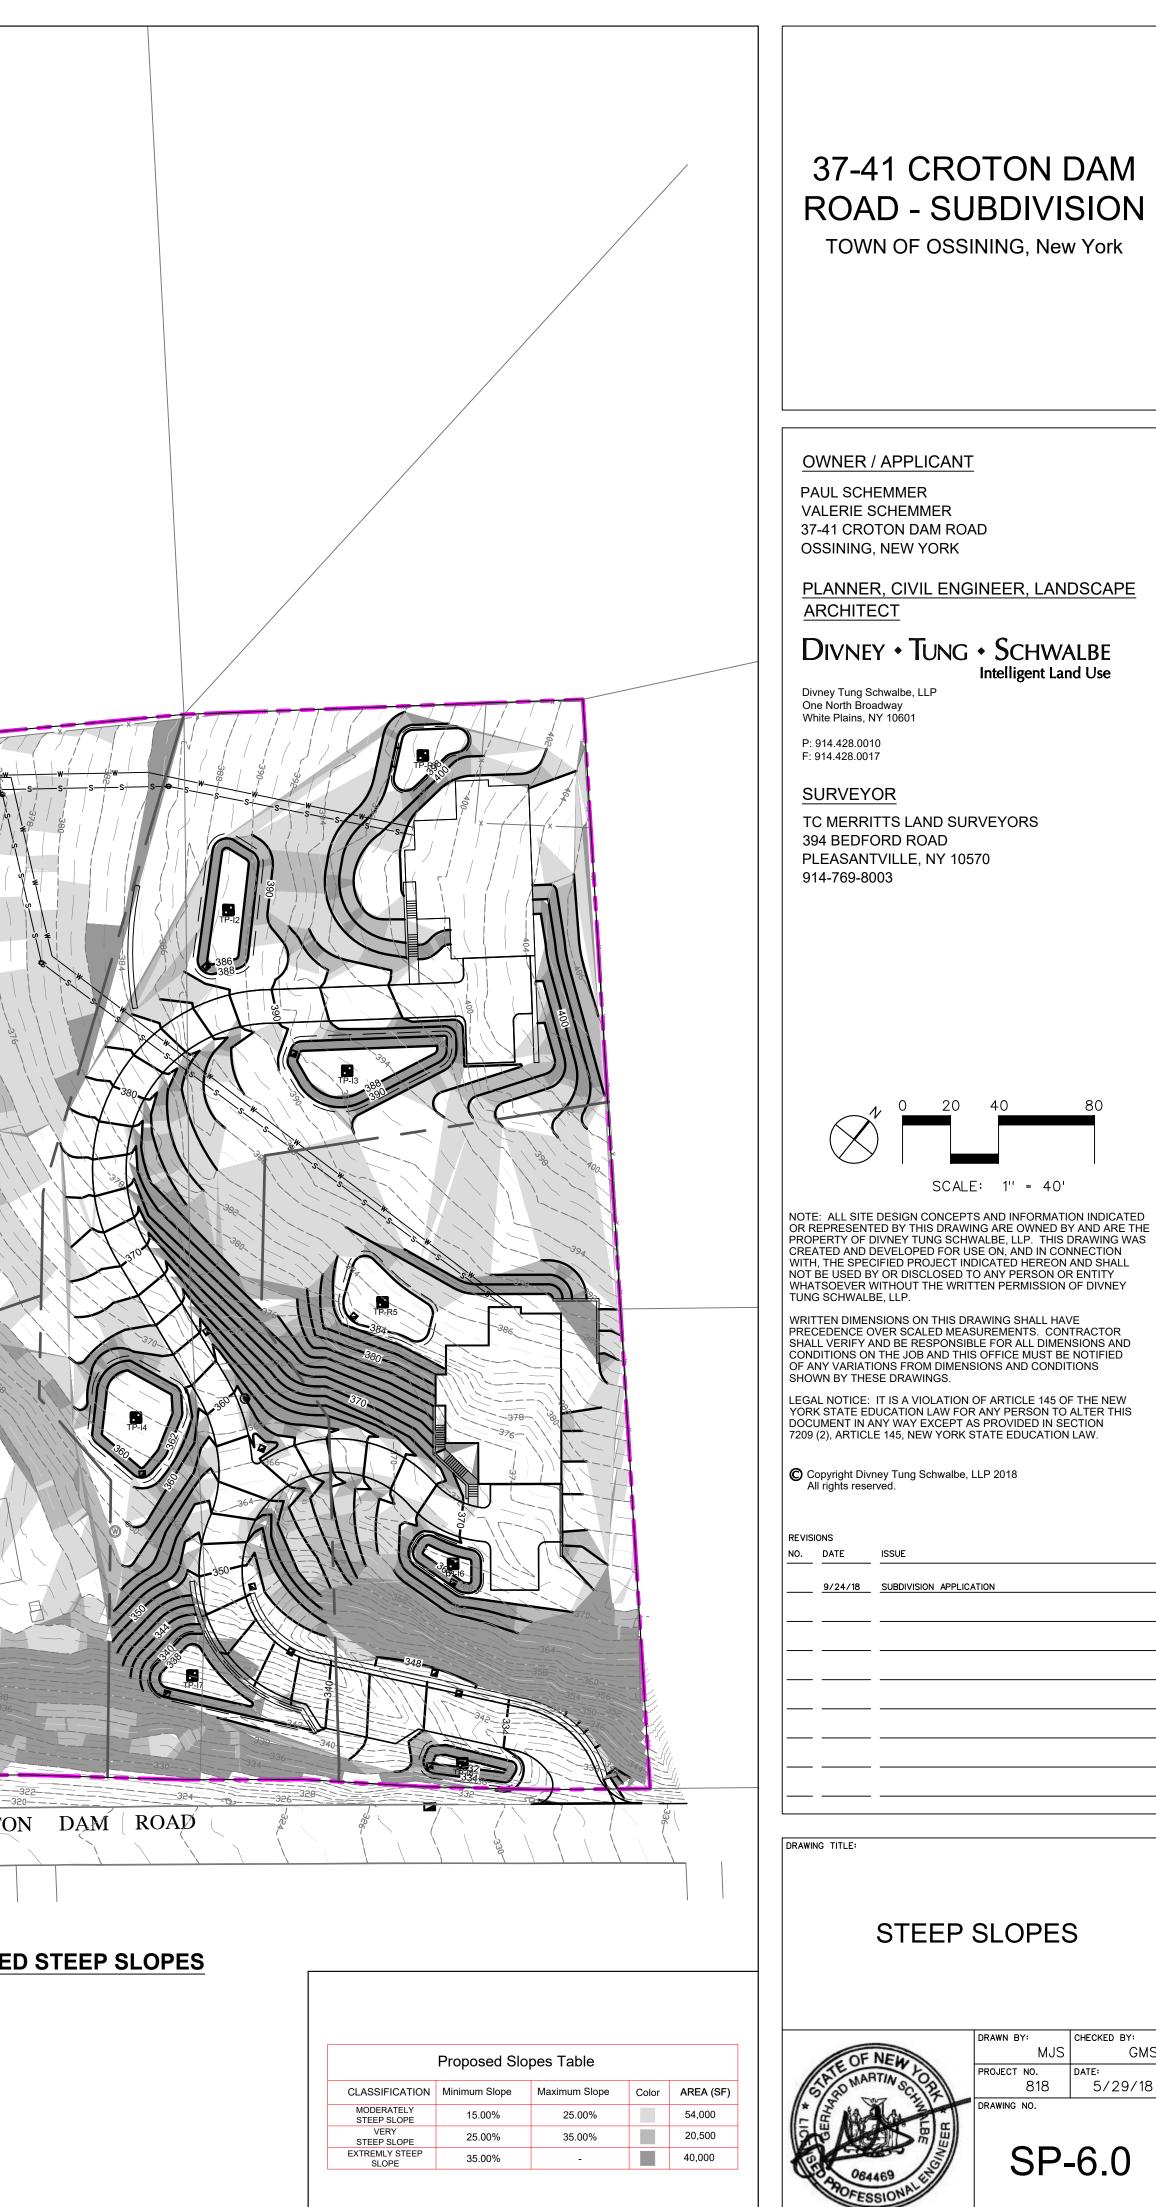



80 SCALE: 1" = 40' NOTE: ALL SITE DESIGN CONCEPTS AND INFORMATION INDICATED OR REPRESENTED BY THIS DRAWING ARE OWNED BY AND ARE THE PROPERTY OF DIVNEY TUNG SCHWALBE, LLP. THIS DRAWING WAS CREATED AND DEVELOPED FOR USE ON, AND IN CONNECTION WITH, THE SPECIFIED PROJECT INDICATED HEREON AND SHALL NOT BE USED BY OR DISCLOSED TO ANY PERSON OR ENTITY WHATSOEVER WITHOUT THE WRITTEN PERMISSION OF DIVNEY TUNG SCHWAI BE LLP


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STEEP SLOPES





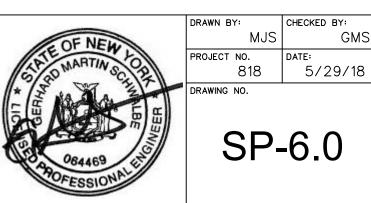

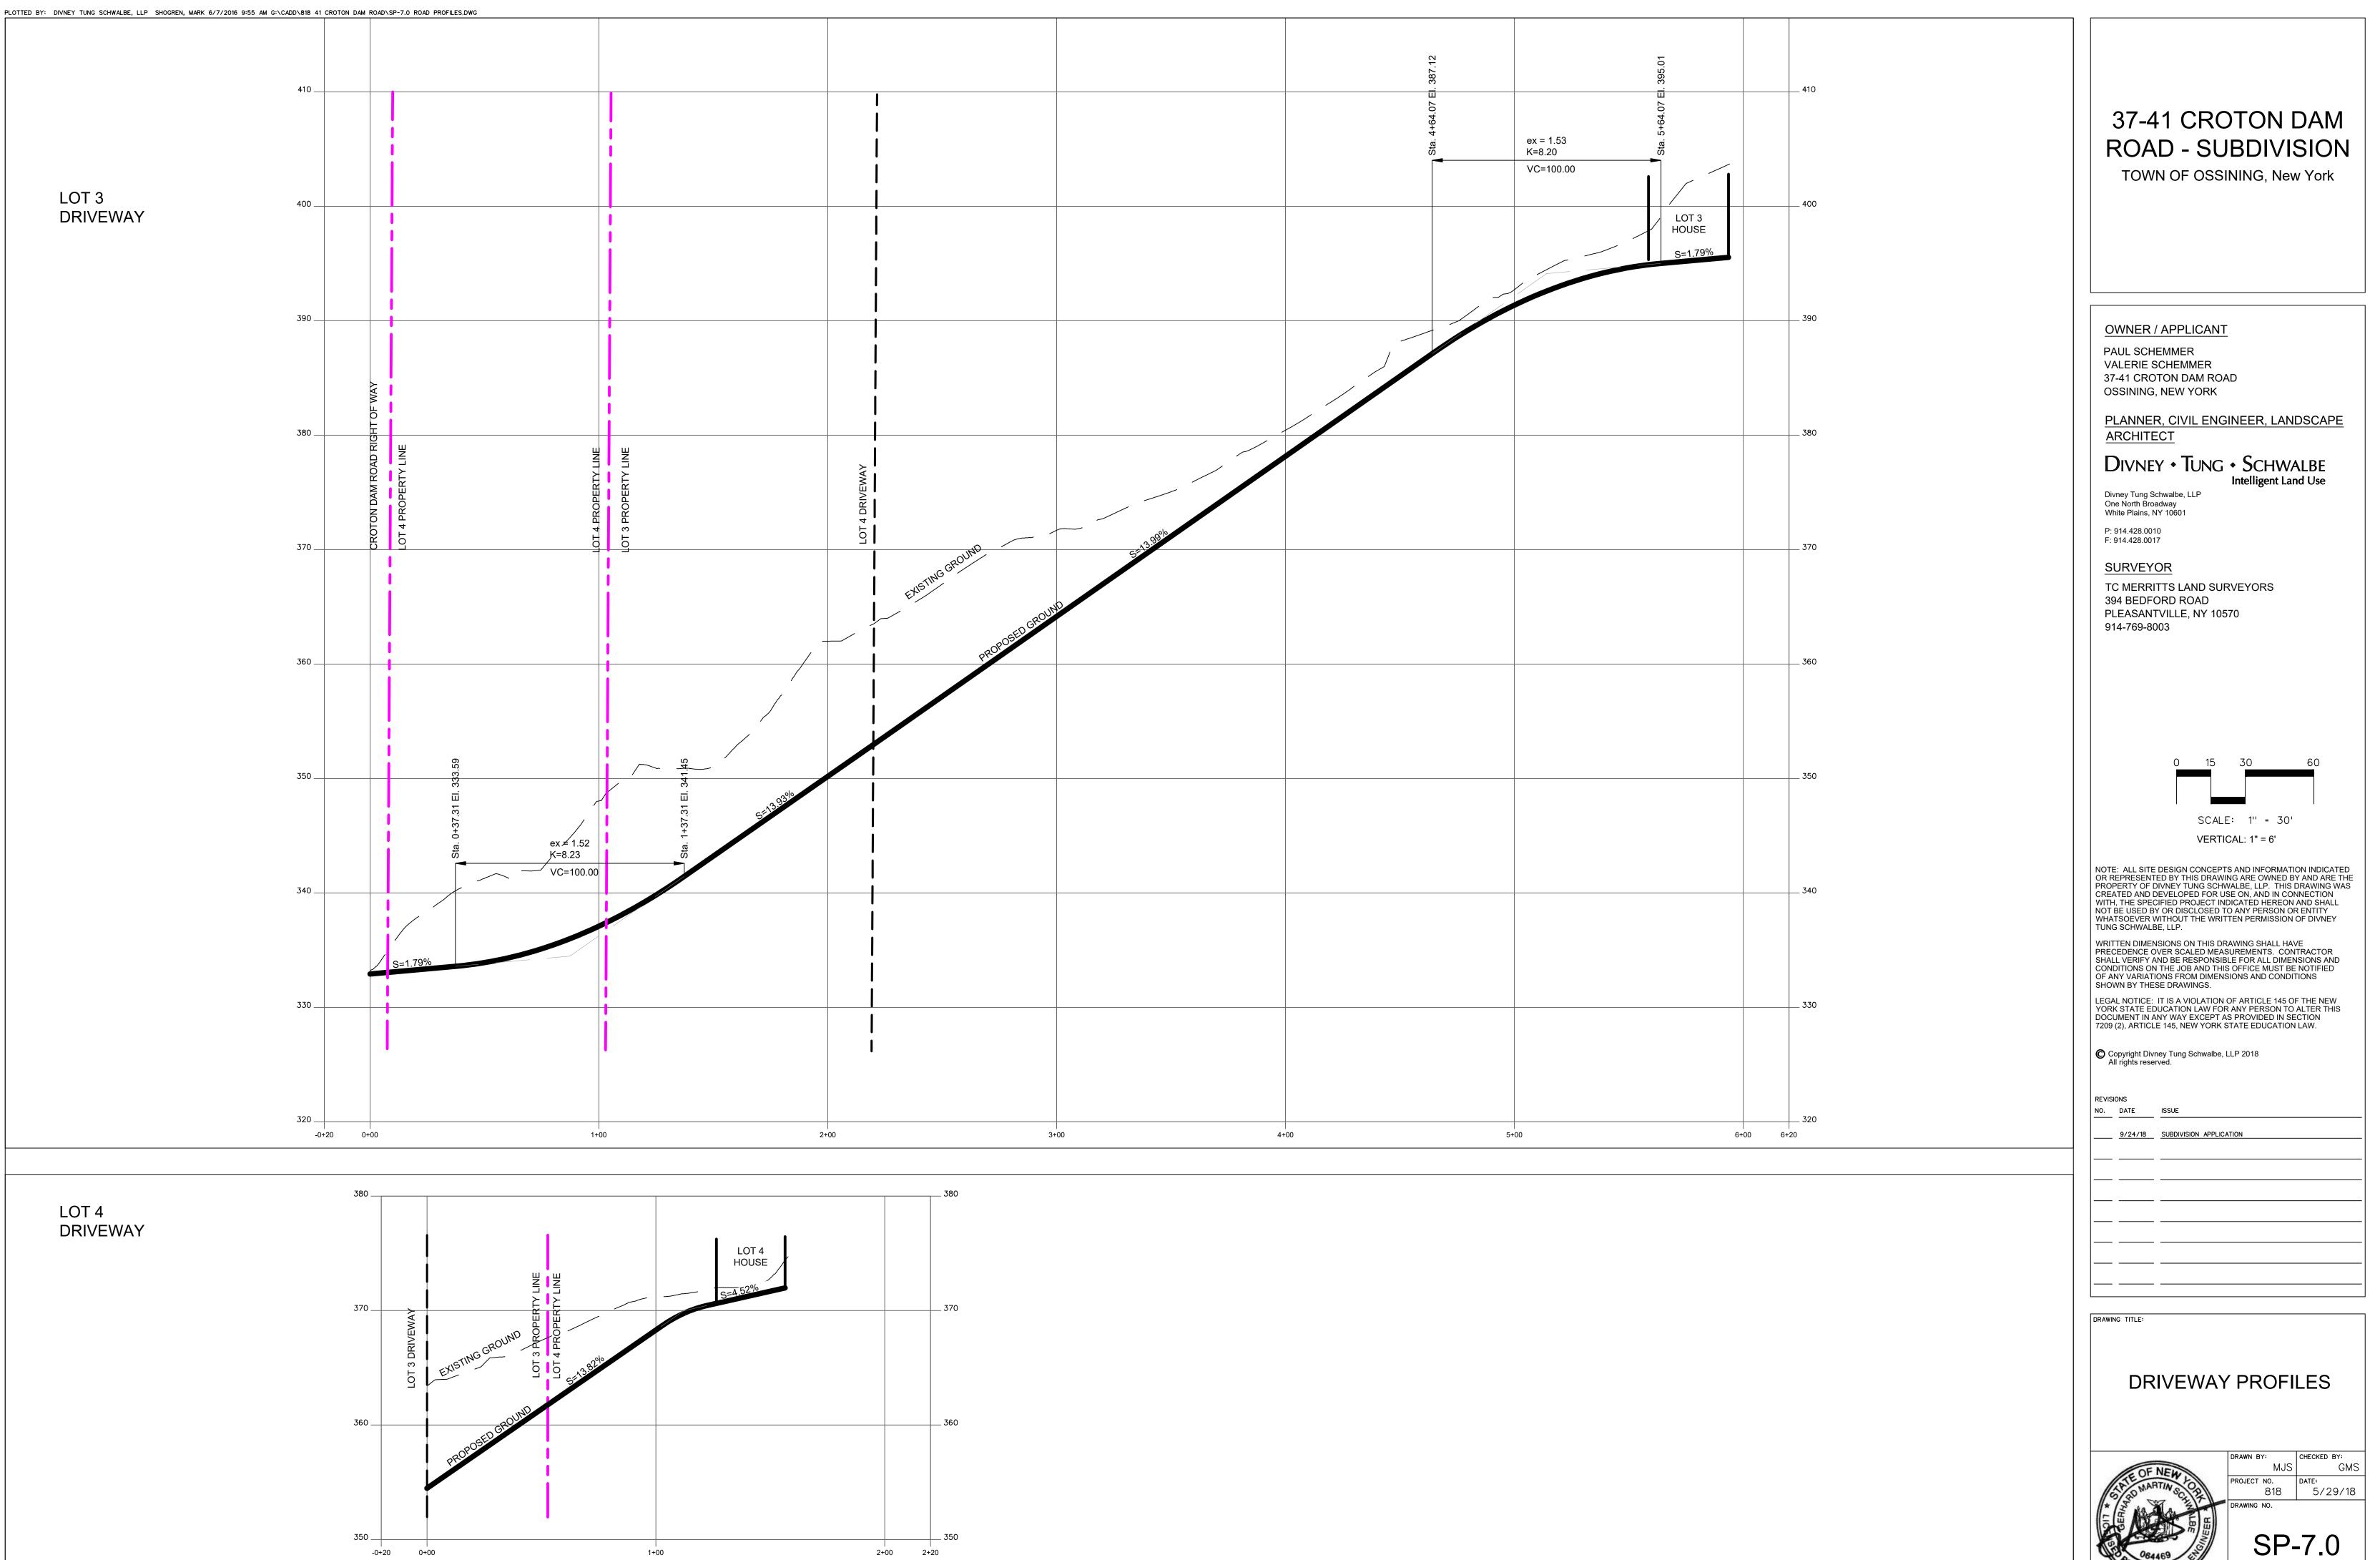Only copies from the original of this topography map marked with an original of the Land Surveyors embossed seal shall be considered to be true, valid copies.

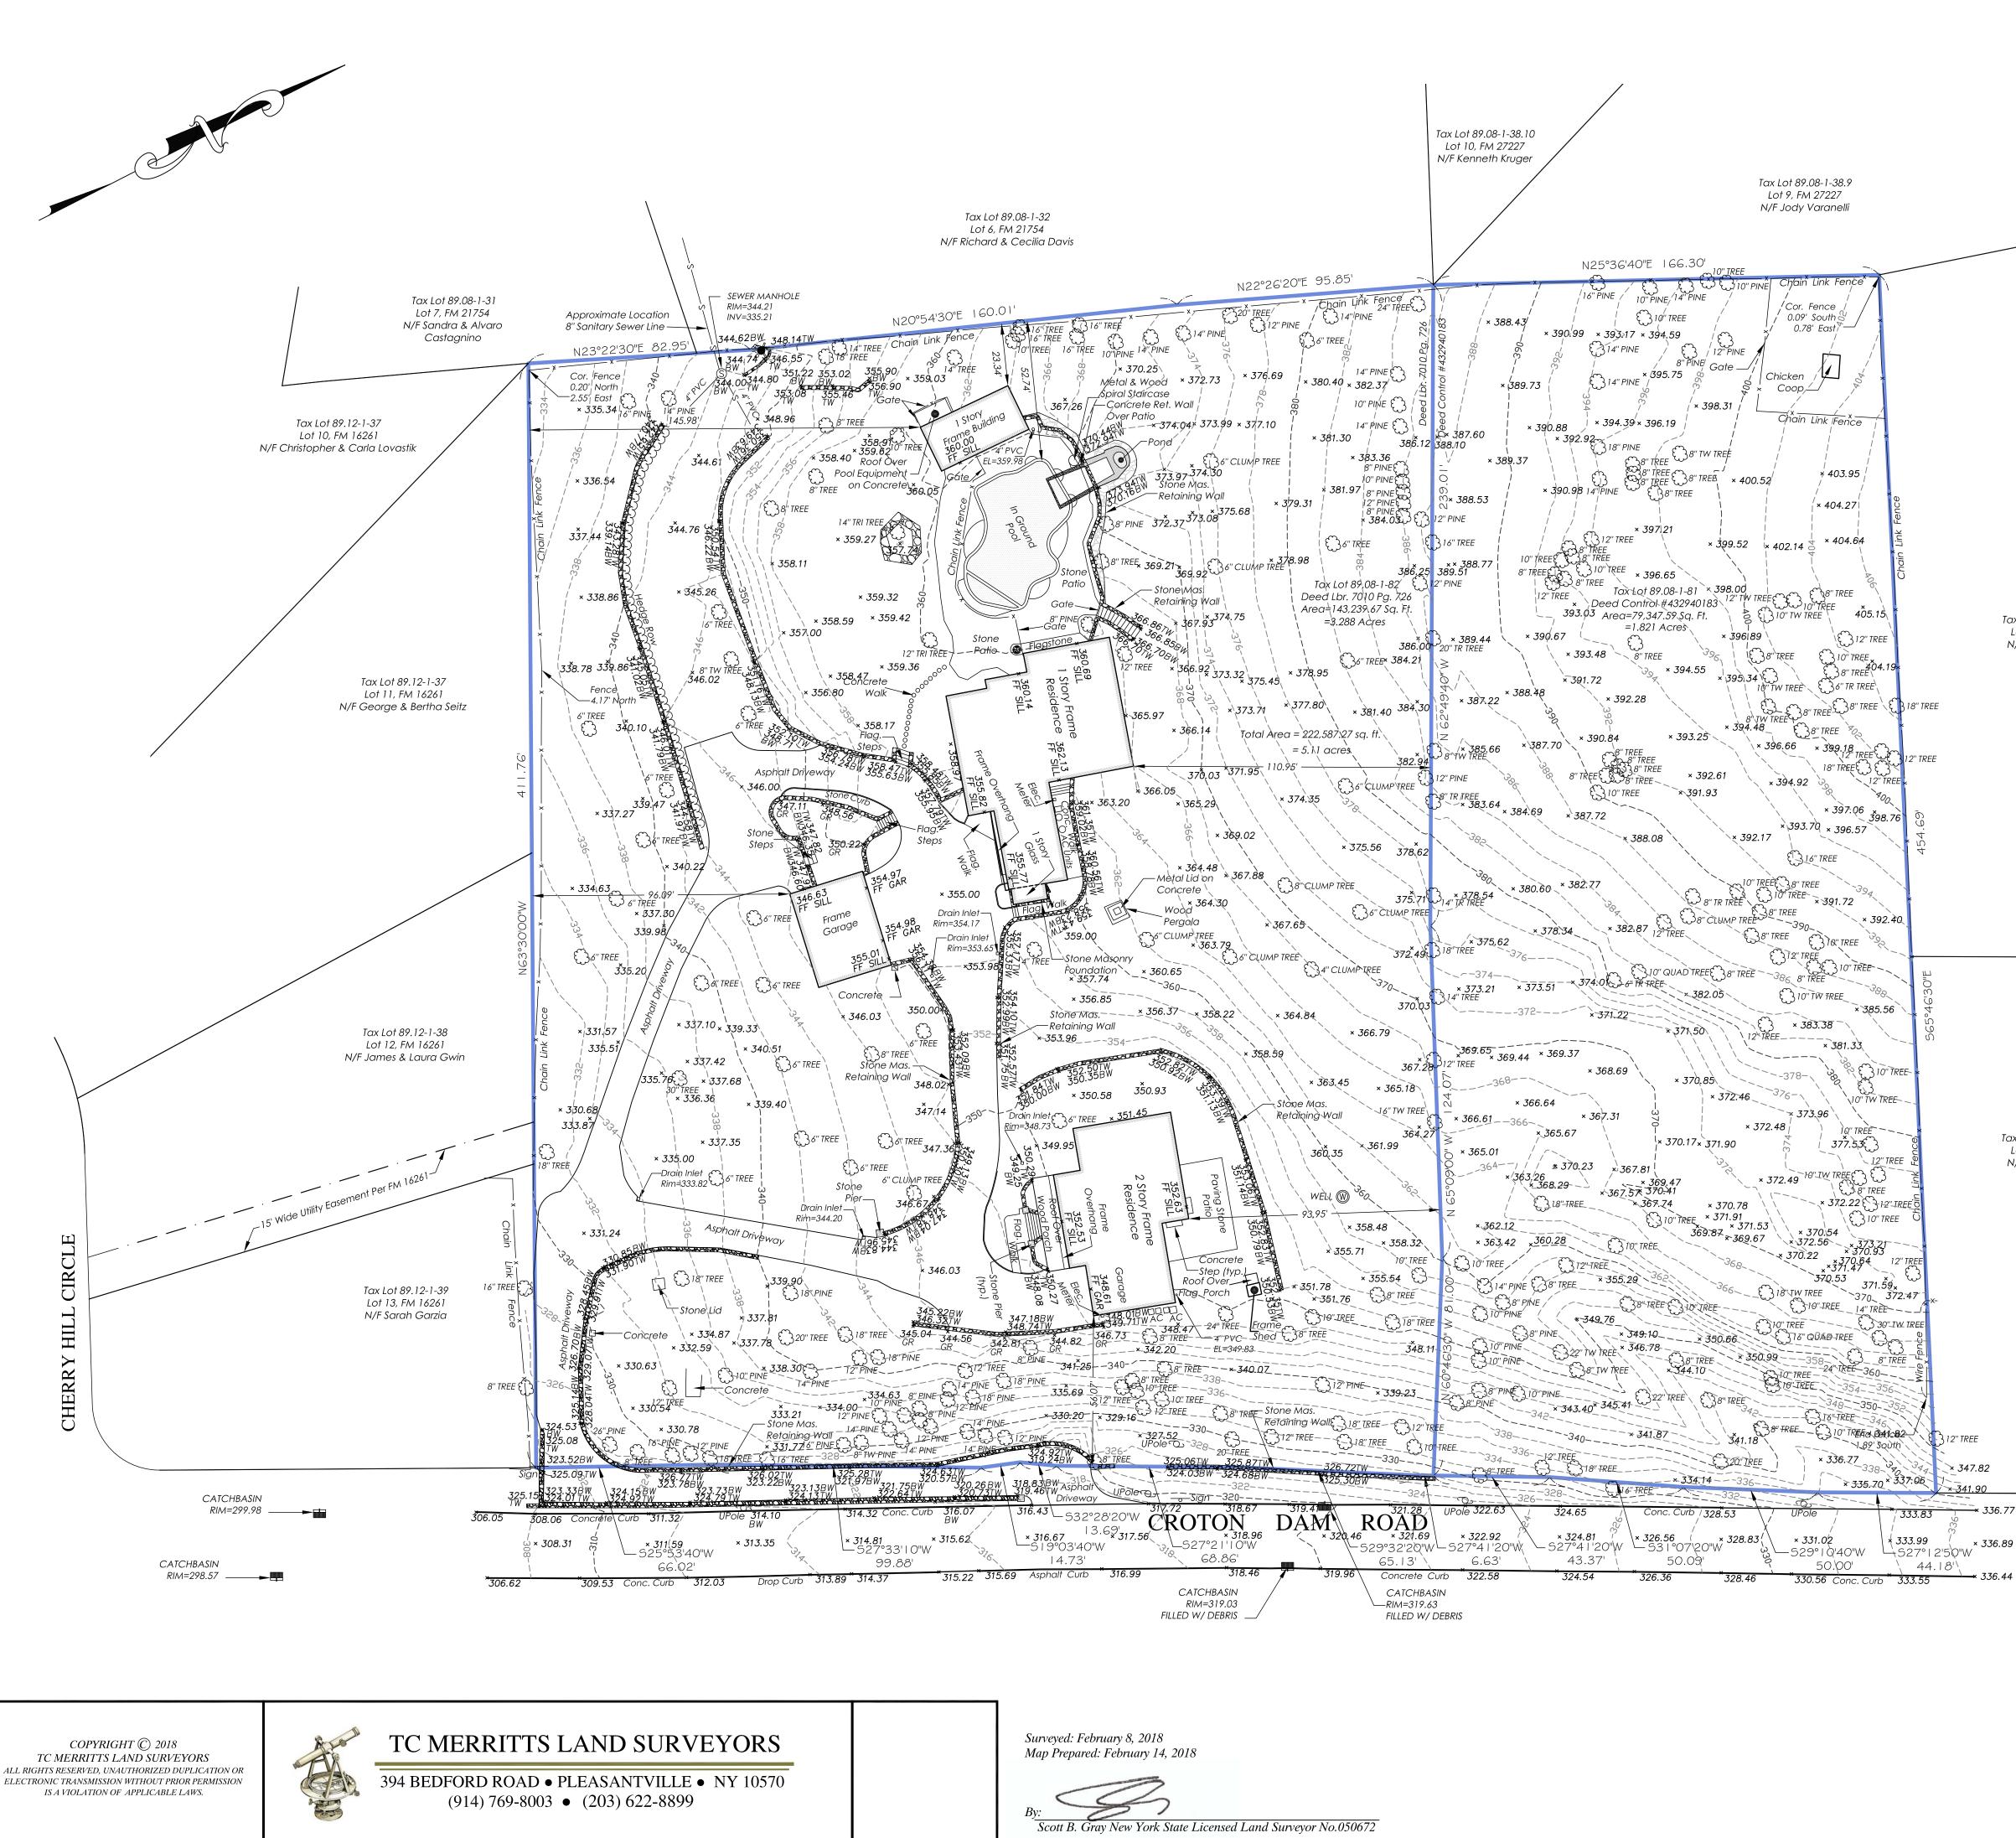Unauthorized alteration or addition to a map bearing a licensed Land Surveyors seal is a violation of Section 7209, Subdivision 2 of the New York State Education Law.

Possession only where indicated.

Adjacent property lines and easements not surveyed or certified. Access to adjacent rights of way, easements and public or private lands not guaranteed or certified.

Underground utilities shown hereon are approximate and should be verified before excavating. Additional underground utilities are not shown or certified.

Encroachments and structures below grade, if any, not shown or certified.

Subject to covenants, easements, restrictions, conditions and agreements of record.

This map is prepared to show topography only and is not to be used for title transfer purposes. Map may not be certified to title companies and/or banks.

Tree species shown hereon to be verified by a licensed arborist and are not certified by surveyor.

Elevations shown hereon generally in accordance with North American Vertical Datum 88.

Tax Lot 89.08-1-80.1 Lot 1, FM 27944 N/F Mario Conte

AS TO TAX LOT 81:

Surveyed in accordance with Deed Control Number 432940183.

Premises shown hereon designated on the Town of Ossining Tax Maps as: Section 89.08, Block 1, Lot 81.

Property Address: 41 Croton Dam Road Ossining, NY 10562

AS TO TAX LOT 82:

Surveyed in accordance with Deed Liber 7010, Page 726.

Premises shown hereon designated on the Town of Ossining Tax Maps as: Section 89.08, Block 1, Lot 82.

Property Address: 37 Croton Dam Road Ossining, NY 10562

Total Area of Tax Lot 81 and Tax Lot 82 = 222,587.26 Sq. Ft. = 5.109 Acres



× 336.7

× 336.89

CATCHBASIN

RIM=343.42

CATCHBASIN

RIM=344.38 _____

TOPOGRAPHY OF PROPERTY PREPARED FOR TAX LOTS 81 AND 82 SITUATE IN THE TOWN OF OSSINING WESTCHESTER COUNTY, NEW YORK

SCALE: 1'' = 30'

GRAPHIC SCALE

 50 C) 1	5 3	ο ε	60 120	ļ
(IN FEET $)1 inch = 30 ft.$					
		1	inch = 30	ft.	

Project: 18-011	Field Survey By: AN/FT
Drawn By: CMP	Checked By: SBG