

IT IS A VIOLATION OF THE LAW FOR ANY PERSON, UNLESS ACTING UNDER THE DIRECTION OF A LICENSED ARCHITECT, TO ALTER AN ITEM IN ANY WAY. IF AN ITEM BEARING THE SEAL OF AN ARCHITECT IS ALTERED, THE ALTERING ARCHITECT SHALL AFFIX TO THIS ITEM THE SEAL AND THE NOTATION "ALTERED BY" FOLLOWED BY HIS/HER SIGNATURE AND THE DATE OF SUCH ALTERATION, AND A SPECIFIC DESCRIPTION OF THE ALTERATION.


REV.	DATE	COMMENT
1	11-11-19	AS PER BLDG. DEP.
2	04-24-20	ZONING CHART
3	05-18-20	AS PER PLAN. BD.
4	05-29-20	AS PER PLAN. BD.
5	06-04-20	AS PER PLAN. BD.
6	06-18-20	AS PER ARB
7	07-08-20	AS PER ARB

EROSION AND SEDIMENT CONTROL NOTES

- CONTRACTOR SHALL BE RESPONSIBLE FOR COMPLIANCE WITH ALL SEDIMENT AND EROSION CONTROL PRACTICES. THE SEDIMENT AND EROSION CONTROL PRACTICES ARE TO BE INSTALLED PRIOR TO ANY SOIL DISTURBANCE AND MAINTAINED UNTIL SITE IS STABILIZED.
- TIMELY MAINTENANCE OF SEDIMENT CONTROL MEASURES IS THE RESPONSIBILITY OF THE CONTRACTOR. ALL SEDIMENT MEASURES SHALL BE MAINTAINED IN GOOD WORKING ORDER. SEDIMENT LEVEL SHALL BE CLOSELY MONITORED AND SEDIMENT REMOVED PROMPTLY WHEN MAXIMUM LEVELS ARE REACHED AND/OR AS DIRECTED BY ARCHITECT. ALL SEDIMENT CONTROL MEASURES SHALL BE INSPECTED WEEKLY, PRIOR TO ANY EXPECTED RAIN EVENTS, AND AFTER EACH HEAVY RAINFALL TO ENSURE PROPER OPERATION AS DESIGNED. AN INSPECTION LOG SHALL BE MAINTAINED BY CONTRACTOR.
- THE LOCATION AND INSTALLATION TIMES OF SEDIMENT MEASURES SHALL BE AS ORDERED BY ARCHITECT AND IN ACCORDANCE WITH ACCEPTED STANDARDS.
- ALL TOPSOIL NOT TO BE USED FOR FINAL GRADING, SHALL BE REMOVED FROM THE SITE IMMEDIATELY AND PLACED IN A STABILIZED STOCKPILE. ALL TOPSOIL REQUIRED FOR FINAL GRADING AND TO BE STORED ON SITE SHALL BE LIMED, FERTILIZED AND TEMPORARILY SEEDDED AND MULCHED WITHIN 14 DAYS.
- ANY DISTURBED AREAS THAT WILL BE LEFT EXPOSED MORE THAN 21 DAYS AND NOT SUBJECT TO CONSTRUCTION TRAFFIC, SHALL IMMEDIATELY RECEIVE TEMPORARY SEEDING, MULCH SHALL BE USED IF THE SEASON PREVENTS ESTABLISHMENT OF A TEMPORARY COVER. DISTURBED AREAS SHALL BE LIMED AND FERTILIZED PRIOR TO TEMPORARY SEEDING.
- ALL DISTURBED AREAS CLOSE TO DWELLINGS SHALL BE WETTED AS NECESSARY TO PROVIDE DUST CONTROL.
- THE CONTRACTOR SHALL KEEP ROADWAY, DRIVEWAY WITHIN THE PROJECT CLEAR OF SOIL AND DEBRIS AND IS RESPONSIBLE FOR ANY STREET CLEANING NECESSARY DURING THE COURSE OF THE PROJECT.
- SEDIMENT AND EROSION CONTROL MEASURES SHALL BE REMOVED WHEN THE AREA AS PROPERLY BEEN STABILIZED BY PERMANENT MEASURES.
- SOIL SEEDING AND FERTILIZING SHALL BE PERFORMED IN ACCORDANCE WITH THE CURRENT EDITION OF "NEW YORK GUIDELINES FOR URBAN EROSION AND SEDIMENT CONTROL".
- ALL SEDIMENT AND EROSION CONTROL MEASURES SHALL BE INSTALLED IN ACCORDANCE WITH THE CURRENT EDITION OF "NEW YORK GUIDELINES FOR URBAN EROSION AND SEDIMENT CONTROL".

3 SILT FENCE DETAIL

N.T.S.

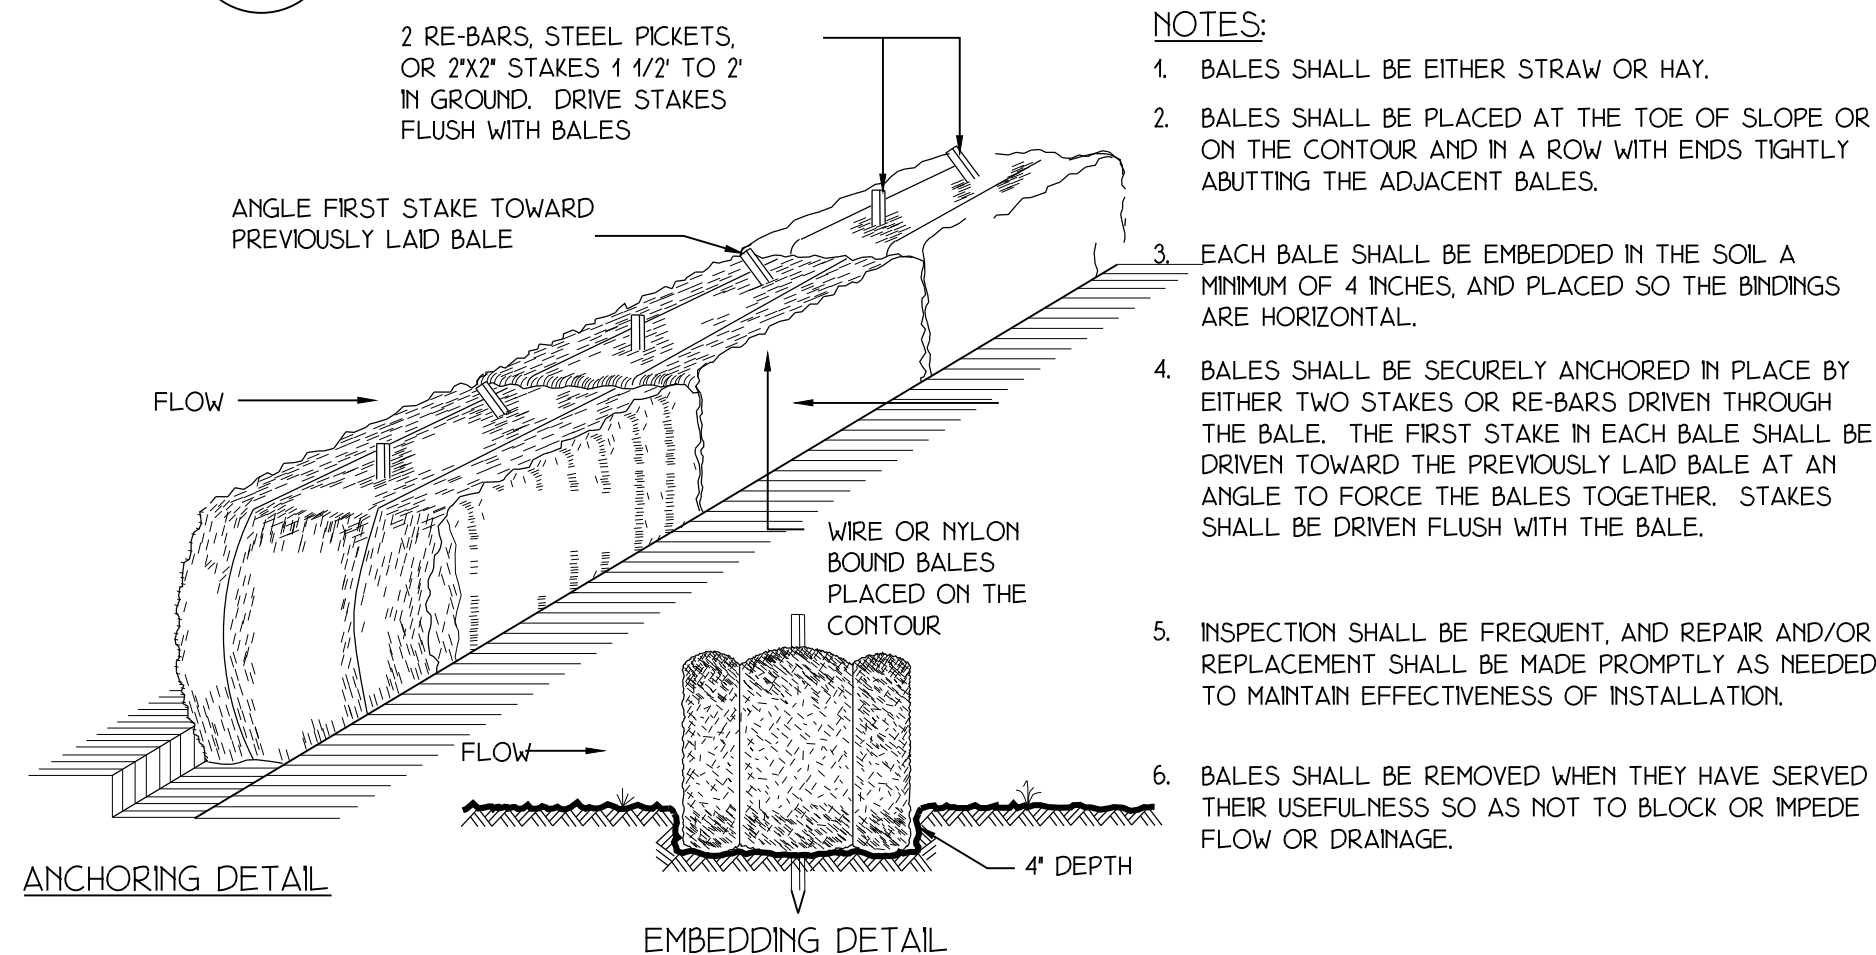


4 STRAWBALE SEDIMENT BARRIERS DETAIL

N.T.S.

5 SOIL STOCKPILING DETAIL

N.T.S.

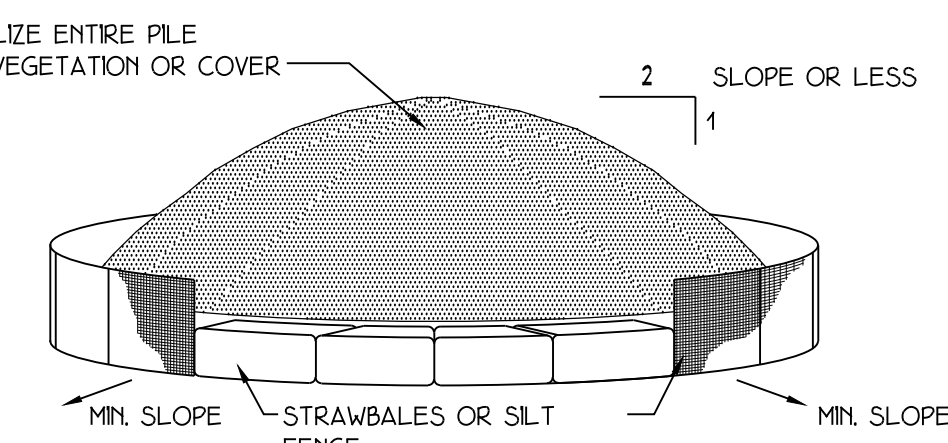

SOIL STOCKPILING NOTES

- AREA CHOSEN FOR STOCKPILING OPERATIONS SHALL BE DRY AND STABLE.
- MAXIMUM SLOPE OF STOCKPILE SHALL BE 1:2.
- UPON COMPLETION OF SOIL STOCKPILING, EACH PILE SHALL BE SURROUNDED WITH EITHER SILT FENCING OR STRAWBALES, THEN STABILIZED WITH VEGETATION OR COVERED.
- SEE DETAIL FOR INSTALLATION OF SILT FENCE.

EROSION CONTROL PLAN, DETAILS AND NOTES

PROJECT INFO


PROPOSED 2 STORY RESIDENCE FOR :

JOHN MARRICCO
125 MORRISIDE DRIVE
OSSINING , NEW YORK 10591

SHEET TITLE:

PROJECT # : 20001
DATE: February 20, 2020
SCALE: AS NOTED
DRAWN BY: RFA, DFA

SEAL:

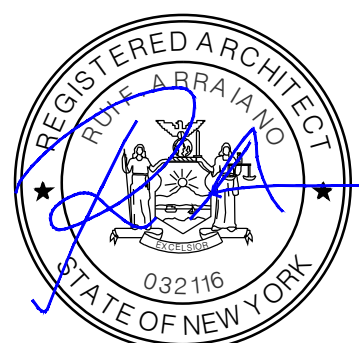

DRAWING:

EC-1