## LOCATION PLAN



# RESTORATION OF SUPERINTENDENT'S COTTAGE DALE CEMETALE RESTORATION OF SUPERINTENDENT'S COTTAGE

LOCATED AT:

104 HAVELL STREET OSSINING, NEW YORK 10522

OWNER:

- SUPERINTENDENT'S COTTAGE AT DALE CEMETERY

TOWN OF OSSINING

ARCHITECT:

STEPHEN TILLY, Architect
22 Elm Street
Dobbs Ferry, New York 10522
Tel. (914) 693 - 8898 Fax (914) 693 - 4235
www.stillyarchitect.com

ISSUED FOR 09-09-2019

# LIST OF ABBREVIATIONS

A/C ACT ADJ AFF ARCH BD BIT BLDG BLK BM BTM CAB CLG CLG HT CT CLO CMU COL CONC CONT CONT CONTR CPT CTR DN DR DWG ELEV EQ EQUIP EXT'G EXT	AIR CONDITIONING ACOUSTICAL TILE ADJUSTABLE ABOVE FINISHED FLOOR ARCHITECTURAL/ARCHITECT BOARD BITUMINOUS BUILDING BLOCK BEAM BOTTOM CABINET CEILING CEILING HEIGHT CERAMIC TILE CLOSET CONCRETE MASONRY UNIT COLUMN CONCRETE CONTINUOUS CONTRACTOR CARPET CENTER DOWN DOOR DRAWING ELEVATION EQUAL EQUIPMENT EXISTING EXTERIOR	LC MIN MISC MO MTD MTL NIC NTS OPNG P/L PLY PSF PSI PT PTD PVC QTY REINF REQD RM RO S&V SHT SIM SPECS SQ FT ST STD STL STOR STRUCT	LEAD COATED MINIMUM MISCELLANEOUS MASONRY OPENING MOUNTED METAL NOT IN CONTRACT NOT TO SCALE OPENING PROPERTY LINE PLYWOOD POUNDS PER SQUARE FOOT POUNDS PER SQUARE INCH POINT PAINTED POLY VINYL CHLORIDE QUANTITY REINFORCED REQUIRED ROOM ROUGH OPENING STAIN AND VARNISH SHEET SIMILAR SPECIFICATIONS SQUARE FOOT/FEET STREET STANDARD STEEL STORAGE STRUCTURAL
EQ	EQUAL		
		STL	STEEL
FIN	FINISH	SUB FLR	
FL/FLR	FLOOR	T&G	TONGUE AND GROOVE
FT FTG	FOOT/FEET FOOTING	TERR	TERRAZZO
GA	GAUGE	THK THRU	THICKNESS THROUGH
GALV	GALVANIZED	TYP	TYPICAL
GC	GENERAL CONTRACTOR	VENT	VENT/VENTILATION
GWB	GYPSUM WALL BOARD	VERT	VERTICAL
GYP BD	GYPSUM WALL BOARD	VIF	VERIFY IN FIELD
HB HDWR	HOSE BIBB HARDWARE	VOL	VOLUME
HORIZ	HORIZONTAL	W/	WITHOUT
HVAC	HEATING VENTILATING & A/C	W/O WD	WITHOUT WOOD
INSUL	INSULATION	WWF	WELDED WIRE FABRIC
INT	INTERIOR	VV VV F	WELDED WIKE FADRIC

## LIST OF DRAWINGS

NUMBER	TITLE	DATE ISSUED
T-100	TITLE SHEET	09-09-2019
D-100	DEMOLITION PLANS AND PHOTOS	09-09-2019
A-100	NEW CONSTRUCTIONS PLANS AND PHOTOS	09-09-2019
A-200	NEW CONSTRUCTION ELEVATIONS	09-09-2019
A-350	PORCH SECTION AND DETAILS	09-09-2019
A-810	WINDOW SCHEDULE AND DETAILS	09-09-2019

# Design Criteria

					<u> </u>						
ROUND				SLISMIC	SUBJECT T	GE FROM	DESIGN   SHIELD	FLOOD HAZARDS	AIR EREEZING		
SNOW LOAD	SPEED (MPH)	TOPOGRAPHIC EFFECTS	SPECIAL WIND REGION	CATEGORY	WEATHER	FROST LINE DEPTH	TERMITE	$\mid \text{TEMP.} \mid \frac{\text{UN}}{\text{RE}}$	UNDERLAY. REQUIRED	TH WE HADS	INDEX
30 lbs./ sf.	100 / 110	N/A	YES	С	SEVERE	42"	MOD. / HVY.	15	YES	HIGH	1500 OR LESS

## GENERAL NOTES

#### GENERAL NOTES:

- I. ALL DIMENSIONS ARE TO NEW ROUGH FRAMING OR TO FINISHED SURFACE OF EXISTING BUILDING UNLESS OTHERWISE NOTED.
- 2. DO NOT SCALE DRAWINGS. USE WRITTEN DIMENSIONS OR VERIFY WITH ARCHITECT.
- 3. THE CONTRACTOR SHALL VERIFY ALL DIMENSIONS, LAYOUT CONSTRUCTIONS, AND EXISTING CONDITIONS IN THE FIELD AND SHALL NOTIFY THE ARCHITECT OF ANY DISCREPANCIES <u>BEFORE</u> STARTING WORK. A PLUS / MINUS (+/-) INDICATES DIMENSIONS WHICH MAY VARY
- 4. ALL EXISTING CONSTRUCTION TO REMAIN SHALL BE PROTECTED FROM DAMAGE DURING CONSTRUCTION, AND LEFT THOROUGHLY CLEAN AND IN THE CONDITION FOUND AT THE BEGINNING OF WORK, OR BETTER.
- 5. PROVIDE PLASTIC BARRIERS TO PREVENT DUST MIGRATION TO AREAS OUTSIDE WORK AREA. MAINTAIN THROUGH DURATION OF CONSTRUCTION.
- NEW AND EXISTING FINISHES, FIXTURES AND EQUIPMENT SUBJECT TO DAMAGE DURING CONSTRUCTION SHALL BE PROTECTED WITH PROTECTIVE COVERINGS, I/4" MASONITE FLOOR PROTECTION SECUREL' TAPED IN PLACE, PLASTIC SHEETING, AND OTHER METHODS AS APPROPRIATE. DAMAGE DUE TO FAILURE TO PROVIDE AND MAINTAIN ADEQUATE PROTECTION SHALL BE REPAIRED OR REPLACED AT ARCHITECT'S OPTION AT NO ADDITIONAL COST TO THE OWNER.
- 7. UPON COMPLETION, ALL HVAC AIR FILTERS SHALL BE REPLACED IN EQUIPMENT SERVING THE WORK AREA AND ZONES ADJACENT TO THE WORK AREA.
- 8. SUBMIT ANY SHOP DRAWINGS FOR ARCHITECT'S APPROVAL.

## DEMOLITION NOTES

#### GENERAL DEMOLITION NOTES:

- I. REMOVAL AND DISPOSAL OF ALL ARCHITECTURAL, STRUCTURAL, MECHANICAL, PLUMBING AND ELECTRICAL ITEMS SHALL BE DONE IN ACCORDANCE WITH DRAWINGS, SPECIFICATIONS, AND ALL APPLICABLE CODES AND LOCAL LAWS.
- 2. CONTRACTOR SHALL BE RESPONSIBLE FOR COORDINATION OF ALL REQUIRED INSPECTIONS, TESTING AND APPROVALS.
- 3. PROVIDE PENETRATIONS AS INDICATED AND REQUIRED FOR PROPOSED NEW CONSTRUCTION.
- 4. REMOVAL AND DISPOSAL OF HAZARDOUS MATERIALS SHALL BE IN ACCORDANCE WITH ALL FEDERAL, STATE, AND LOCAL GOVERNING BODIES HAVING JURISDICTION, AND BY WORKERS LICENSED TO PERFORM THE WORK.
- 5. ELECTRICAL AND PLUMBING ITEMS SHALL BE REMOVED BY LICENSED ELECTRICIANS AND PLUMBERS, AND PROPERLY DISCONNECTED AND CAPPED AS REQUIRED BY CODE.
- 6. DO NOT REMOVE OR ALTER STRUCTURAL ELEMENTS EXCEPT WHERE SPECIFICALLY INDICATED. PROVIDE TEMPORARY BRACING AND SHORING APPROVED BY THE STRUCTURAL ENGINEER WHEREVER REMOVAL OR ALTERATION OF FRAMING IS REQUIRED.
- 7. PROTECT AND MAINTAIN THE FUNCTIONALITY OF ALL LIFE SAFETY ELEMENTS, INCLUDING FIRE, SMOKE, AND CARBON MONOXIDE DETECTORS AND ALARMS, FIRE SUPPRESSION SYSTEMS, ETC.
- 8. USE OF CUTTING TORCHES IS STRICTLY PROHIBITED.
- 9. DISPOSE OF REMOVED ITEMS AND MATERIALS IN COMPLIANCE WITH ALL STATE, COUNTY AND LOCAL REGULATIONS. BURNING IS PROHIBITED.
- IO. PROVIDE PLASTIC BARRIERS TO PREVENT DUST MIGRATION TO AREAS OUTSIDE DEMOLITION AREA. MAINTAIN THROUGH DURATION OF CONSTRUCTION.
- II. PROVIDE AND MAINTAIN PROTECTION FROM RAIN AT ALL OPENINGS.

  MAINTAIN DRY CONDITIONS WITHIN THE BUILDING AT ALL TIMES.
- 12. FINISHES, FIXTURES AND EQUIPMENT INDICATED TO REMAIN AND SUBJECT TO DAMAGE DURING DEMOLITION SHALL BE PROTECTED WITH PROTECTIVE PADS, I/4" MASONITE FLOOR PROTECTION SECURELY TAPED IN PLACE, PLASTIC SHEETING, AND OTHER METHODS AS APPROPRIATE. DAMAGE DUE TO FAILURE TO PROVIDE PROPER PROTECTION SHALL BE REPAIRED OR REPLACED AT ARCHITECT'S OPTION AT NO ADDITIONAL COST TO THE OWNER.
- 13. ALL EXISTING CONSTRUCTION TO REMAIN SHALL BE PROTECTED FROM DAMAGE DURING DEMOLITION, CLEANED, AND LEFT IN THE CONDITION FOUND AT THE BEGINNING OF WORK, OR BETTER.
- 14. NOISY OPERATIONS ARE LIMITED TO THE HOURS OF 9:00 AM TO 5:00 PM, MONDAY THROUGH FRIDAY UNLESS OTHERWISE APPROVED BY THE OWNER.
- 15. MAINTAIN WORK AREAS AT A NEGATIVE PRESSURE RELATIVE TO THE REMAINDER OF THE BUILDING, AND COVER OPENINGS INTO ADJACENT SPACES.
- 16. REPAIR OR INSTALL NEW FIRE SAFING OR CLOSURES AT ALL OPENINGS AND PENETRATIONS THROUGH FLOORS AND FIRE WALLS, USING MATERIALS AND METHODS APPROVED BY THE BUILDING OFFICIAL.

Architect
22 Elm Street
Dobbs Ferry, New York 10522
Tel: (914) 693-8898 Fax 693-4235

email: office@stillyarchitect.com

STEPHEN TILLY,

OI O9-O9-2019 ENTIRE S

Sept 09, 2019 Issued for Town Review
April 12, 2019 Issued for Town Review

Issued For

Submissions:

Project: SUPERINTENDENT'S
COTTAGE
DALE CEMETERY
OSSINING, NY

Date: April 12, 2019


Title: TITLE SHEET, GENERAL NOTES

Scale: As Noted

Drawn by: sy, sr, da, sos

TITLE SHEET, GENERAL NOTES

T-100

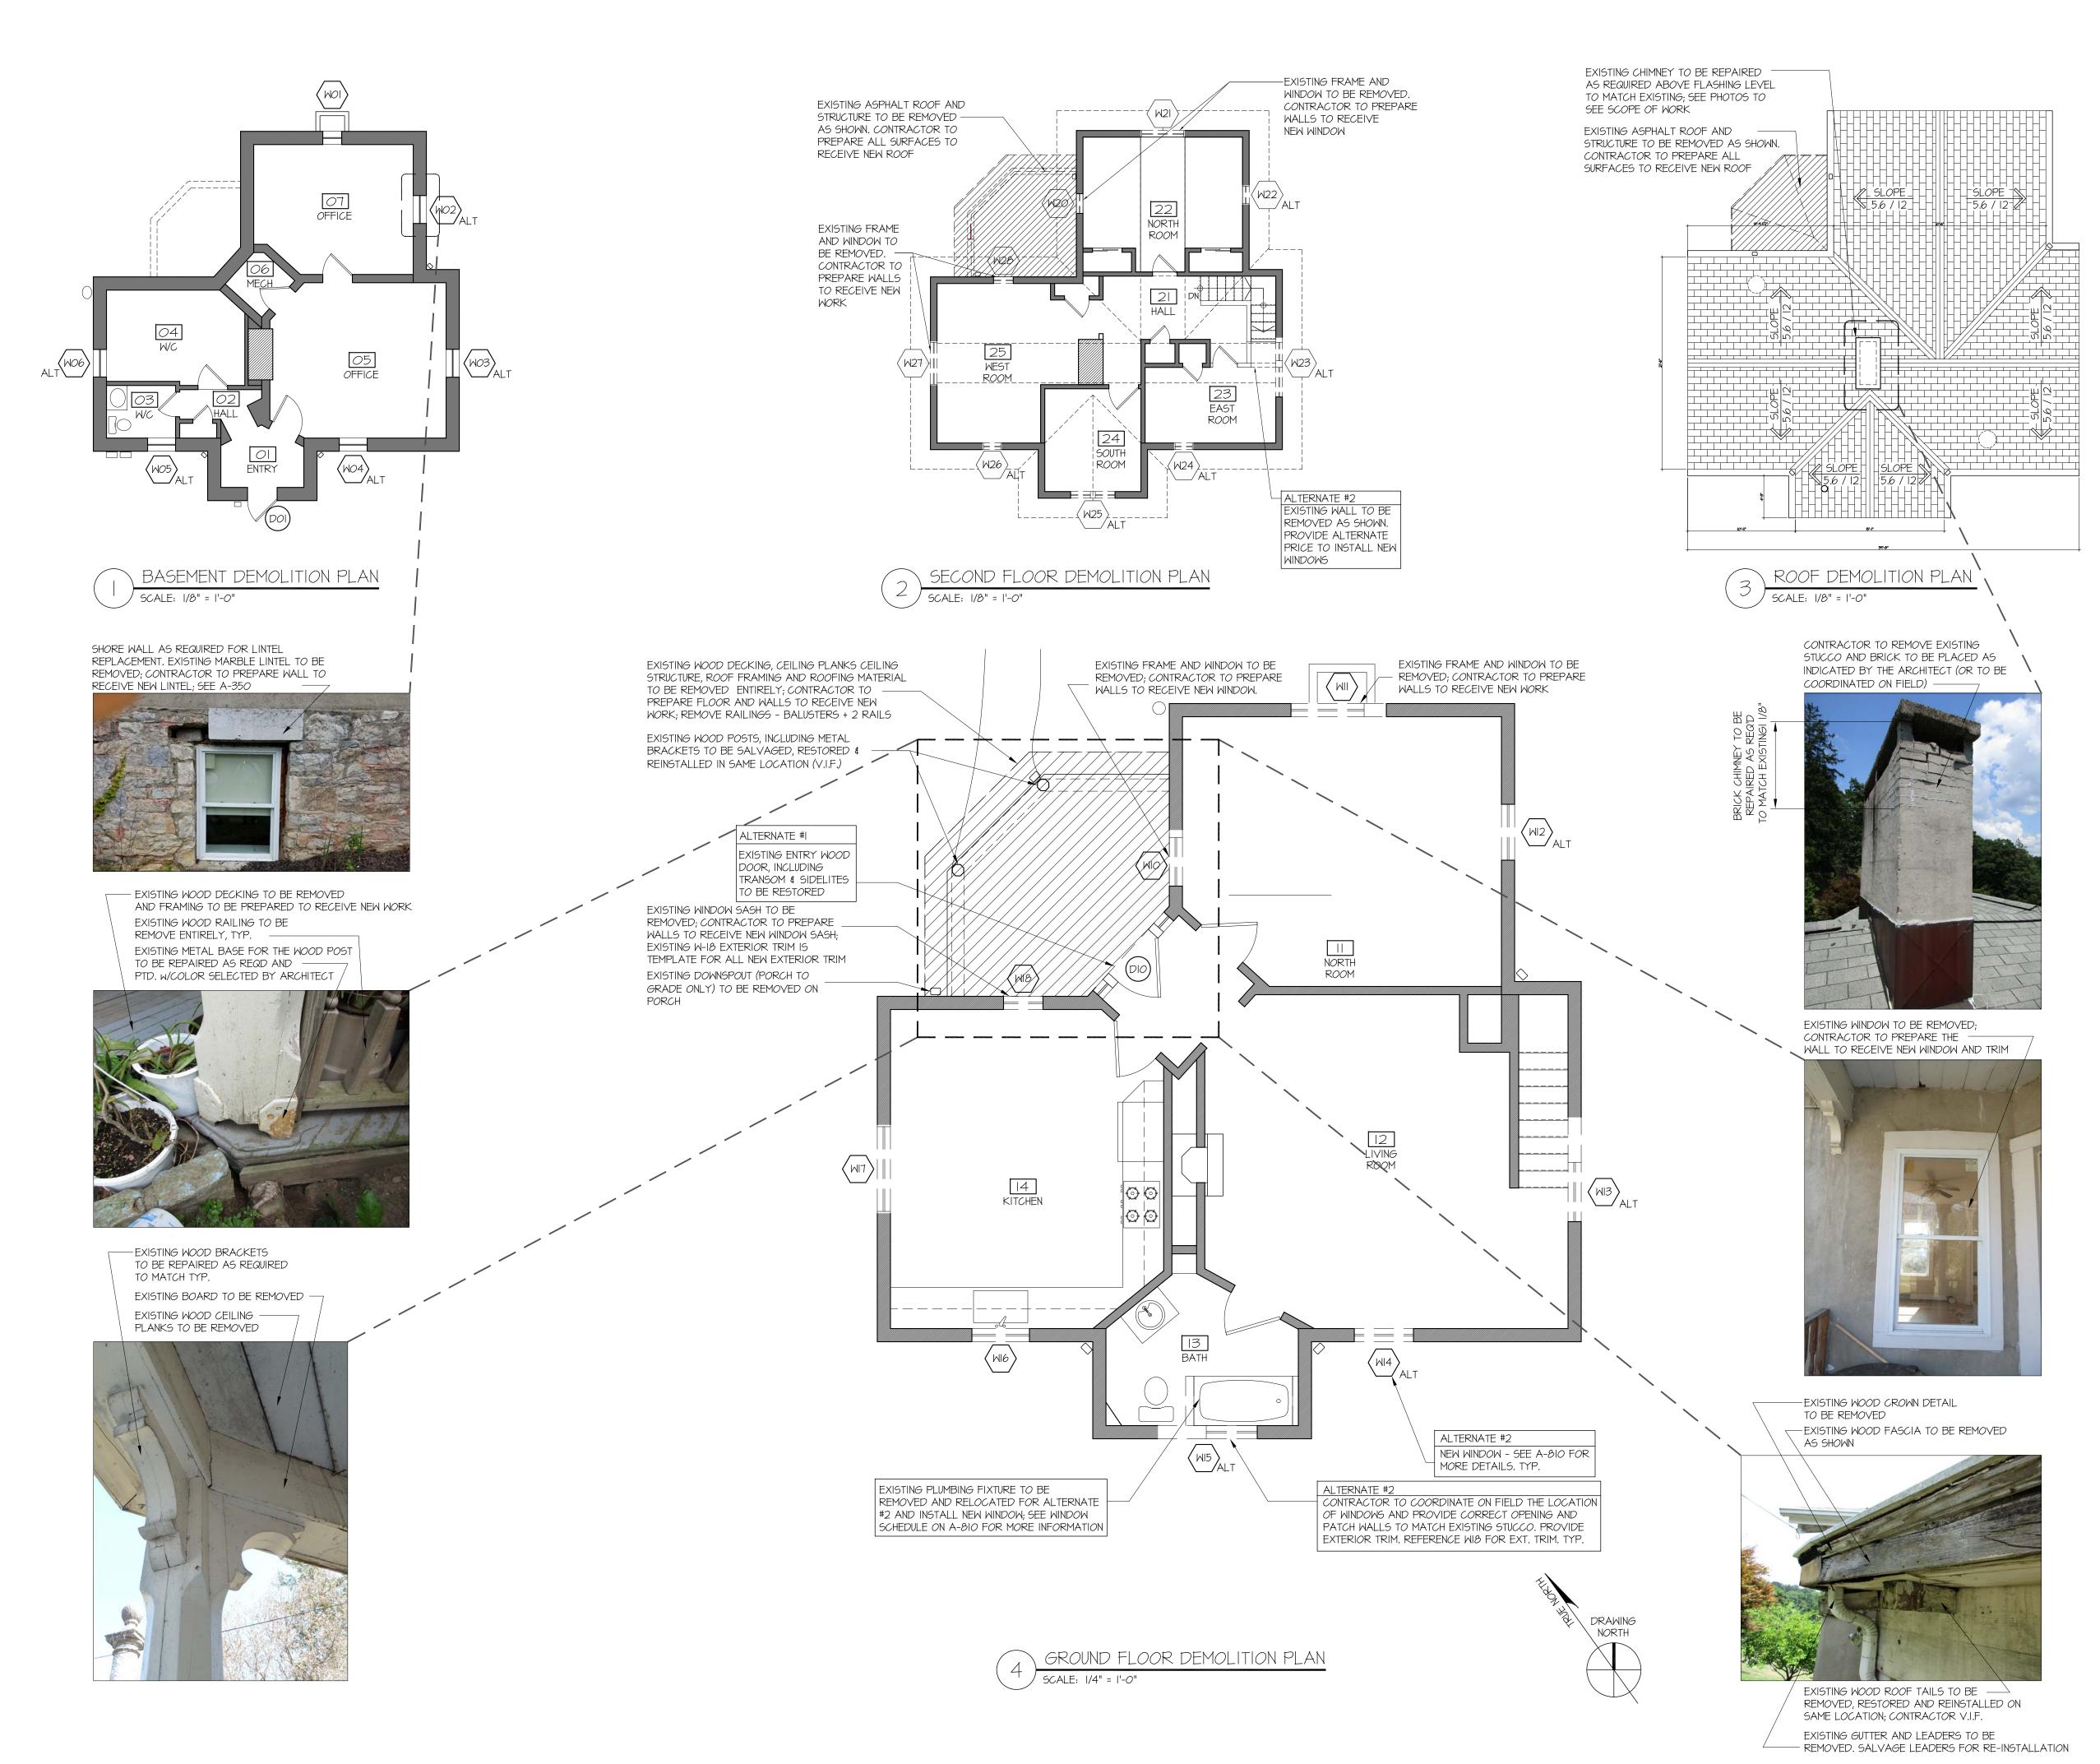

#### STEPHEN TILLY, Architect

22 Elm Street Dobbs Ferry, New York 10522 Tel: (914) 693-8898 Fax 693-4235 email: office@stillyarchitect.com

ALTERNATE #1: FRONT DOOR

ALTERNATE NOTES:

RESTORE THE EXISTING FRONT DOOR, INCLUDING TRANSOM AND SIDELITES. REPLACE PLEXIGLASS LITES WITH CATEGORY I SAFETY GLASS PER CODE. REPAIR/REPLACE MUNTINS AS REQUIRED. RETAIN AND CLEAN EXISTING DOOR HARDWARE. PREP AND PAINT.

ALTERNATE #2: ADDITIONAL NEW WINDOWS
REPLACE THE IST. AND 2ND. FLOOR WINDOWS ON THE EAST AND SOUTH ELEVATIONS WITH CUSTOM OR MARVIN WINDOWS. SEE DRAWING A-810. WINDOWS MATCH OR ARE SIMILAR IN DETAIL TO THOSE OF THE BASE SCOPE ON THE NORTH AND WEST ELEVATIONS, INCLUDING MUNTINS, NEW TRIM.)

ALTERNATE #3: PORCH ROOF UPGRADE UPGRADE THE PORCH ROOF FROM THE BASE SCOPE OF ROLLED ASPHALT TO SOLDERED FLAT-SEAM, LEAD COATED COPPER.

ALTERNATE #4: MAIN ROOF, ASPHALT SHINGLE REPLACE EXISTING ROOF WITH NEW ASPHALT SHINGLE ROOF, INCLUDING COPPER FLASHING/DRIP EDGE; RESTORE/REPLACE AND PAINT ROOF EAVES, RAFTER TAILS; INSTALL NEW COPPER-PAINTED ALUMINUM 5" HALF-ROUND GUTTERS AND 4" ROUND LEADERS

ALTERNATE #5: MAIN ROOF, METAL PANEL REPLACE EXISTING ROOF WITH NEW ATAS STANDING SEAM METAL PANEL ROOF, INCLUDING COPPER/APPROPRIATE FLASHING/DRIP EDGE; RESTORE/REPLACE AND PAINT ROOF EAVES, RAFTER TAILS; INSTALL NEW COPPER PAINTED ALUMINUM 5" HALF-ROUND GUTTERS AND 4" ROUND LEADERS. CHANGE EXISTING COPPER CHIMNEY

ALTERNATE #6: PAINT ALL STUCCO PAINT ENTIRE STUCCO EXTERIOR ONE COLOR, AS IDENTIFIED BY ARCHITECT.

ALTERNATE #7: CHIMNEY UPGRADE UPGRADE FROM BASE SCOPE OF REBUILDING EXISTING TO MATCHING BRICK WITH CORBELS AS SHOWN IN 1865 IMAGE.

#### GENERAL NOTES:

FLASHING TO ALUMINUM.

- ALL DIMENSIONS ARE TO NEW ROUGH FRAMING OR TO FINISHED SURFACE OF EXISTING BUILDING UNLESS OTHERWISE NOTED.
- 2. DO NOT SCALE DRAWINGS. USE WRITTEN DIMENSIONS OR VERIFY WITH ARCHITECT.
- 3. THE CONTRACTOR SHALL VERIFY ALL DIMENSIONS, LAYOUT CONSTRUCTIONS, AND EXISTING CONDITIONS IN THE FIELD AND SHALL NOTIFY THE ARCHITECT OF ANY DISCREPANCIES BEFORE STARTING WORK. A PLUS / MINUS (+/-) INDICATES DIMENSIONS WHICH MAY VARY.

01 09-09-2019 ENTIRE SET No. Date Description

Revisions:

Sept 09, 2019 Issued for Town Review

April 12, 2019 Issued for Town Review

**Issued For** 

Submissions:

Project: SUPERINTENDENT'S COTTAGE DALE CEMETERY

OSSINING, NY


April 12, 2019


DEMOLITION PLANS AND PHOTOS

Scale: As Noted

Drawn by: sy, sr, da, sos

DEMOLITION PLANS AND PHOTOS

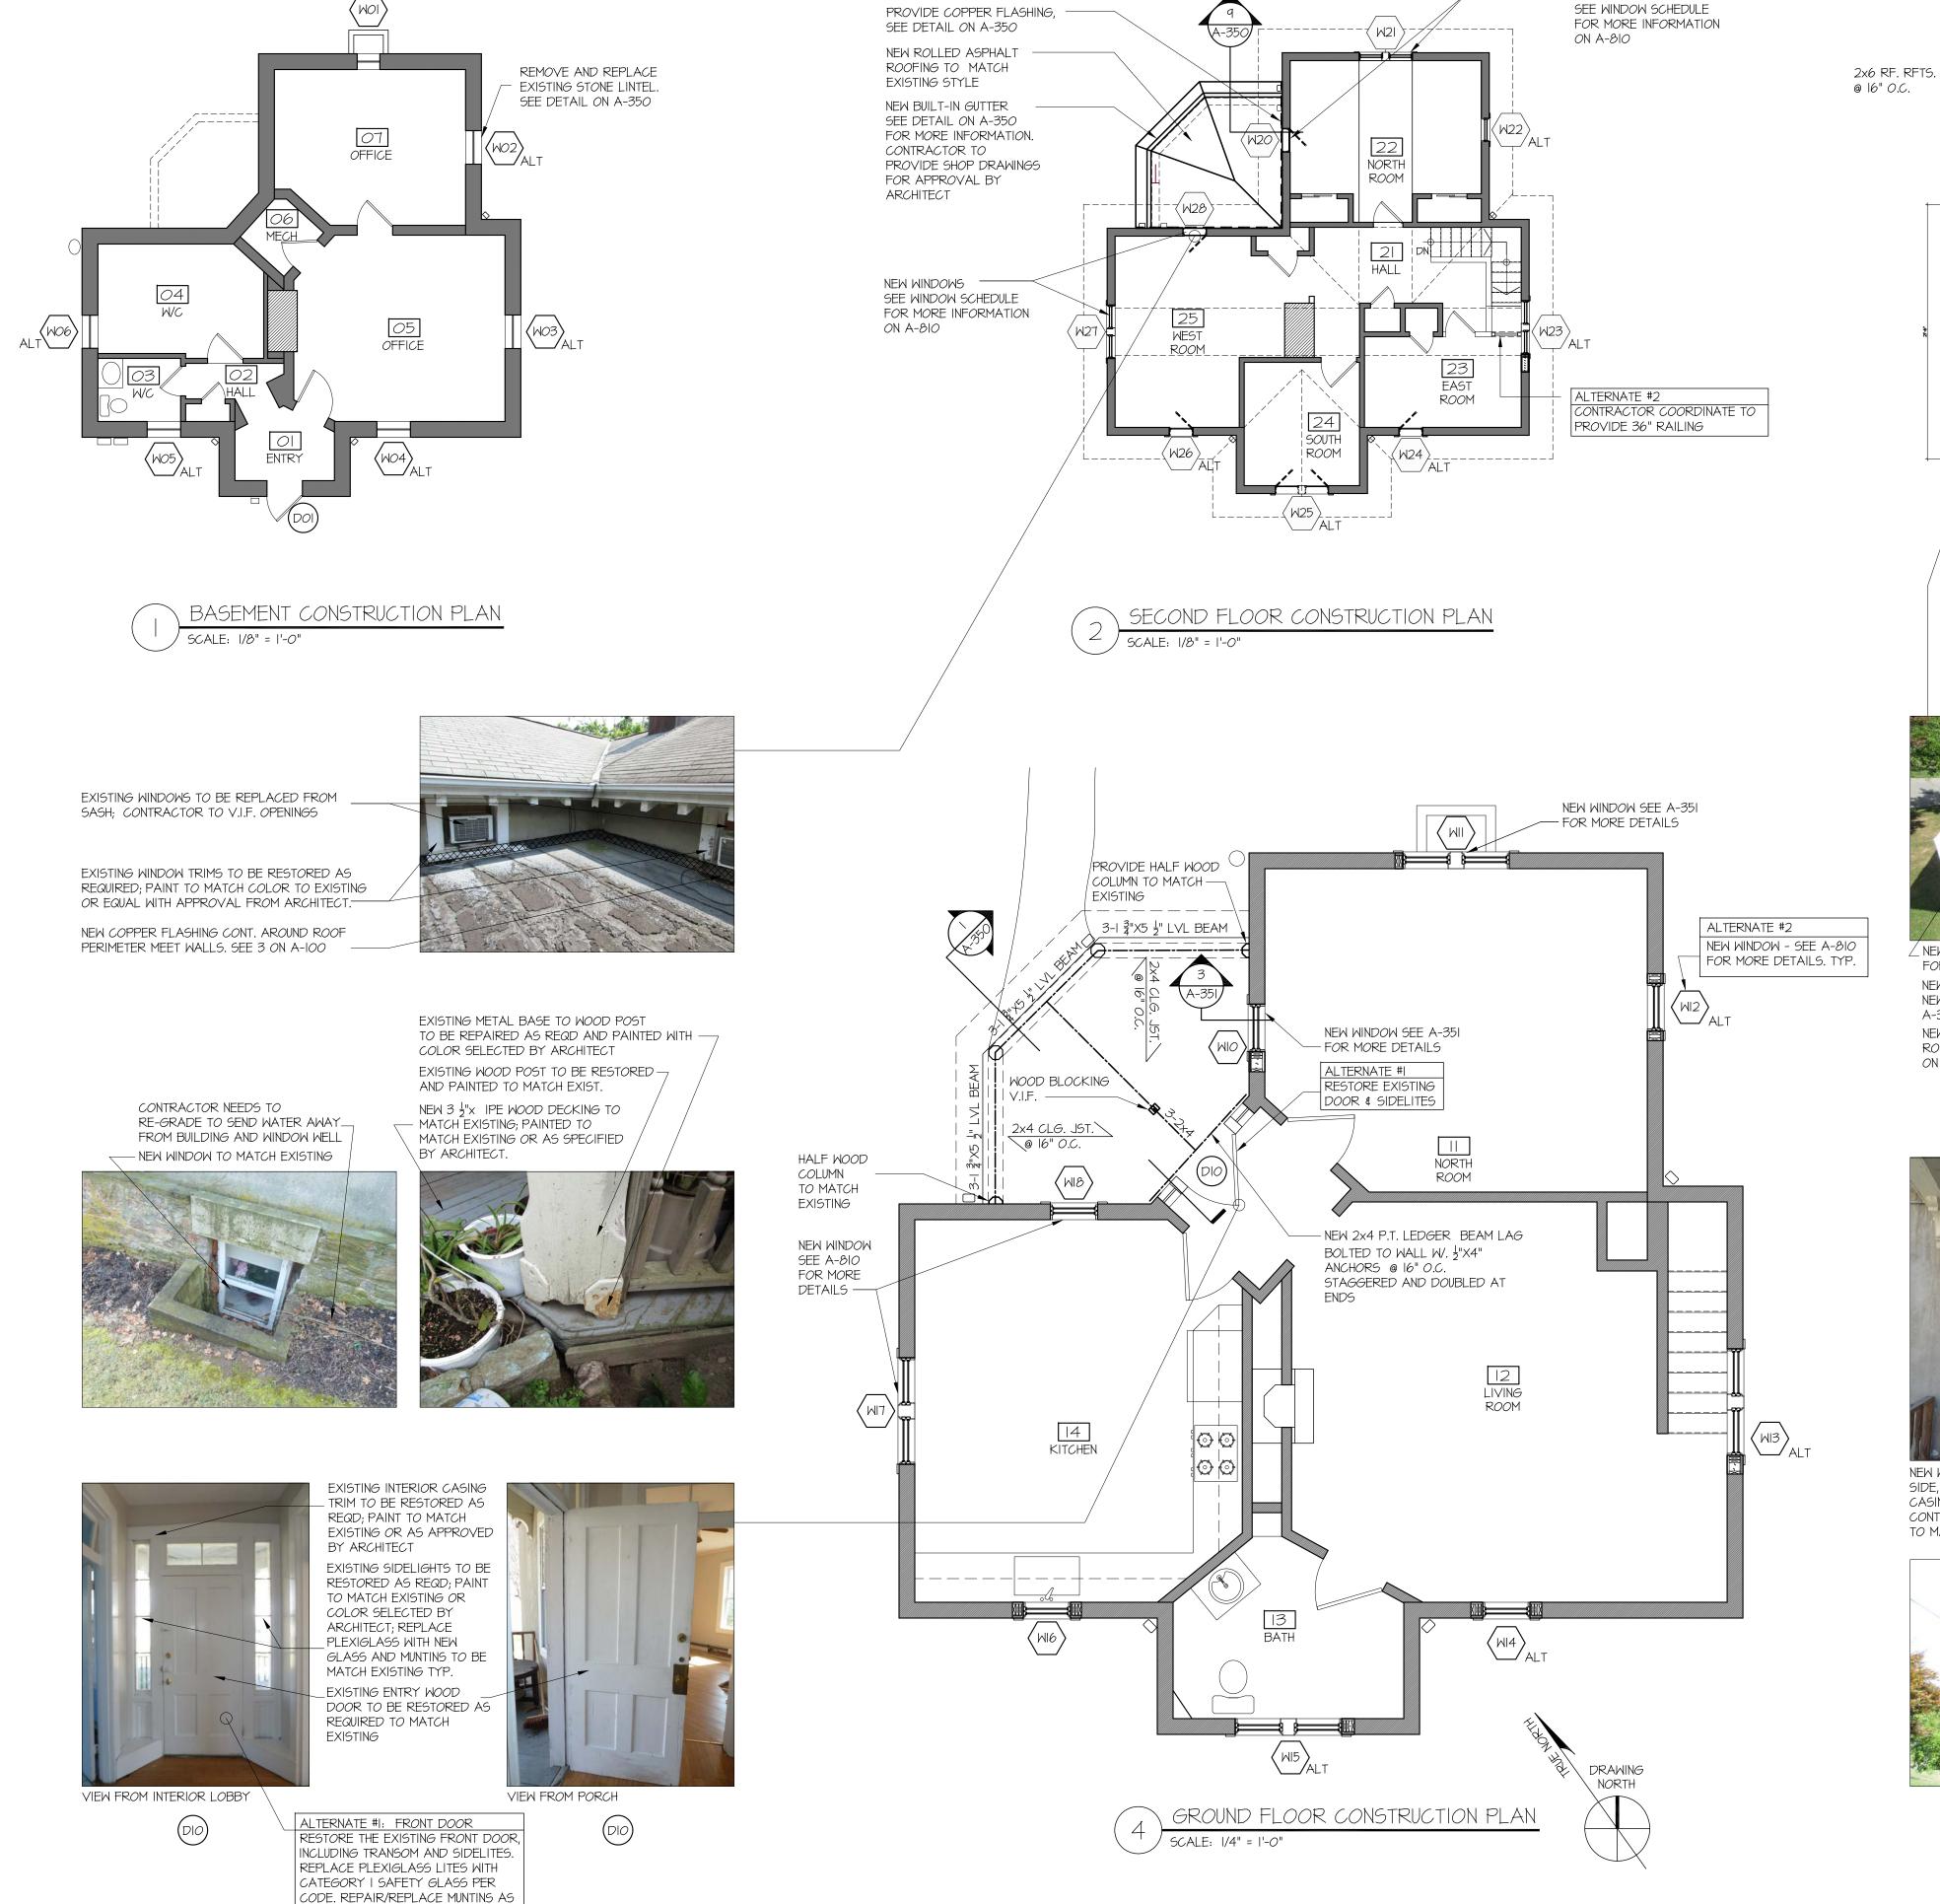

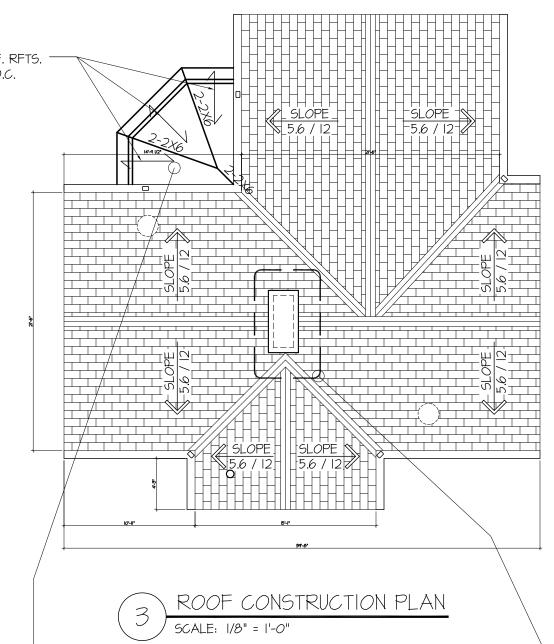


NEW WINDOWS

∠NEW IN-BUILT GUTTER SEE I ON A-350 FOR MORE INFORMATION NEW ROOFING TO BE INSTALLED OVER NEW ROOF FRAMING. SEE DETAIL I ON

NEW COPPER FLASHING CONT. AROUND ROOF PERIMETER MEET WALLS. SEE 2 -ON A-100

> EXISTING EXT WOOD TRIM TO MATCH EXISTING — CONTRACTOR INSTALL NEW WINDOW TO MATCH EXISTING DIMENSION OF WIS WINDOW /

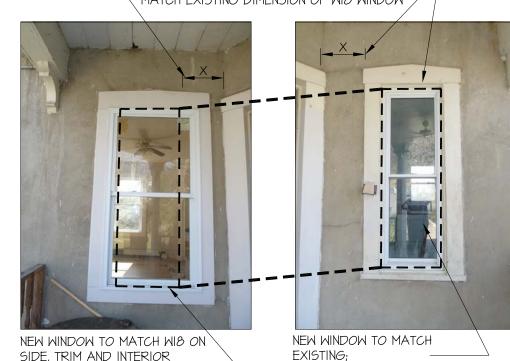

SIDE, TRIM AND INTERIOR CASING TO MATCH EXISTING; CONTRACTOR TO PATCH WALL TO MATCH EXISTING STUCCO.

NEW CROWN MOLDING TO MATCH EXISTING CONTRACTOR V.I.F. STYLE

CONTRACTOR TO VERIFY

OPENING IN FIELD

AND DIMENSIONS TO MATCH NEW IX PT WOOD FASCIA TO MATCH EXISTING

NEW IX PT WOOD SOFFIT TO MATCH EXISTING EXISTING ROOF TAILS TO BE SALVAGED TO BE RESTORED

AND REINSTALLED IN SAME LOCATION

ALL DIMENSIONS ARE TO NEW ROUGH FRAMING OR TO FINISHED SURFACE OF EXISTING BUILDING UNLESS OTHERWISE NOTED.

. THE CONTRACTOR SHALL VERIFY ALL DIMENSIONS, LAYOUT CONSTRUCTIONS, AND EXISTING CONDITIONS IN THE FIELD AND SHALL NOTIFY THE ARCHITECT OF ANY DISCREPANCIES BEFORE STARTING WORK. A PLUS / MINUS (+/-) INDICATES DIMENSIONS WHICH MAY VARY.

STEPHEN TILLY, Architect

22 Elm Street

Dobbs Ferry, New York 10522 Tel: (914) 693-8898 Fax 693-4235

email: office@stillyarchitect.com

01 09-09-2019 ENTIRE SET No. Date Description

Revisions:

Sept 09, 2019 Issued for Town Review April 12, 2019 Issued for Town Review

> Issued For **Submissions:**

Project: SUPERINTENDENT'S COTTAGE DALE CEMETERY

OSSINING, NY

and Photos

NEW CONSTRUCTION

As Noted

Drawn by: sy, sr, da, sos

FLASHING/DRIP EDGE; RESTORE/REPLACE AND PAINT ROOF EAVES, RAFTER TAILS; INSTALL NEW COPPER-PAINTED ALUMINUM 5" HALF-ROUND GUTTERS AND 4" ROUND LEADERS ALTERNATE #5: MAIN ROOF, METAL PANEL

REPLACE EXISTING ROOF WITH NEW ATAS STANDING SEAM METAL PANEL ROOF, April 12, 2019 INCLUDING COPPER/APPROPRIATE FLASHING/DRIP EDGE; RESTORE/REPLACE AND PAINT ROOF EAVES, RAFTER TAILS; INSTALL New Construction Plans NEW COPPER PAINTED ALUMINUM 5" HALF-ROUND GUTTERS AND 4" ROUND LEADERS. CHANGE EXISTING COPPER CHIMNEY

ALTERNATE #6: PAINT ALL STUCCO PAINT ENTIRE STUCCO EXTERIOR ONE COLOR, AS IDENTIFIED BY ARCHITECT.

EXIST. BRICK CHIMNEY & CAP TO BE

REPAIRED OR REPLACED IN-KIND AS

- REQUIRED. CONTRACTOR TO PROVIDE

SAMPLES OF MATERIALS FOR

ARCHITECT'S APPROVAL

ALTERNATE #1: FRONT DOOR

RESTORE THE EXISTING FRONT DOOR,

DOOR HARDWARE. PREP AND PAINT.

INCLUDING TRANSOM AND SIDELITES. REPLACE

PLEXIGLASS LITES WITH CATEGORY I SAFETY

GLASS PER CODE. REPAIR/REPLACE MUNTINS

AS REQUIRED. RETAIN AND CLEAN EXISTING

ALTERNATE #2: ADDITIONAL NEW WINDOWS

ON THE EAST AND SOUTH ELEVATIONS WITH

REPLACE THE IST. AND 2ND. FLOOR WINDOWS

CUSTOM OR MARVIN WINDOWS. SEE DRAWING

A-810. WINDOWS MATCH OR ARE SIMILAR IN

DETAIL TO THOSE OF THE BASE SCOPE ON THE NORTH AND WEST ELEVATIONS, INCLUDING

ALTERNATE #3: PORCH ROOF UPGRADE

SHINGLE ROOF, INCLUDING COPPER

UPGRADE THE PORCH ROOF FROM THE BASE

ALTERNATE #4: MAIN ROOF, ASPHALT SHINGLE REPLACE EXISTING ROOF WITH NEW ASPHALT

SCOPE OF ROLLED ASPHALT TO SOLDERED FLAT-SEAM, LEAD COATED COPPER.

ALTERNATE NOTES:

MUNTINS, NEW TRIM.)

ALTERNATE #7: CHIMNEY UPGRADE UPGRADE FROM BASE SCOPE OF REBUILDING EXISTING TO MATCHING BRICK WITH CORBELS AS SHOWN IN 1865 IMAGE.

GENERAL NOTES:

FLASHING TO ALUMINUM.


. DO NOT SCALE DRAWINGS. USE WRITTEN DIMENSIONS OR VERIFY WITH ARCHITECT.

PLANS AND PHOTOS

REQUIRED. RETAIN AND CLEAN

AND PAINT.

EXISTING DOOR HARDWARE. PREP

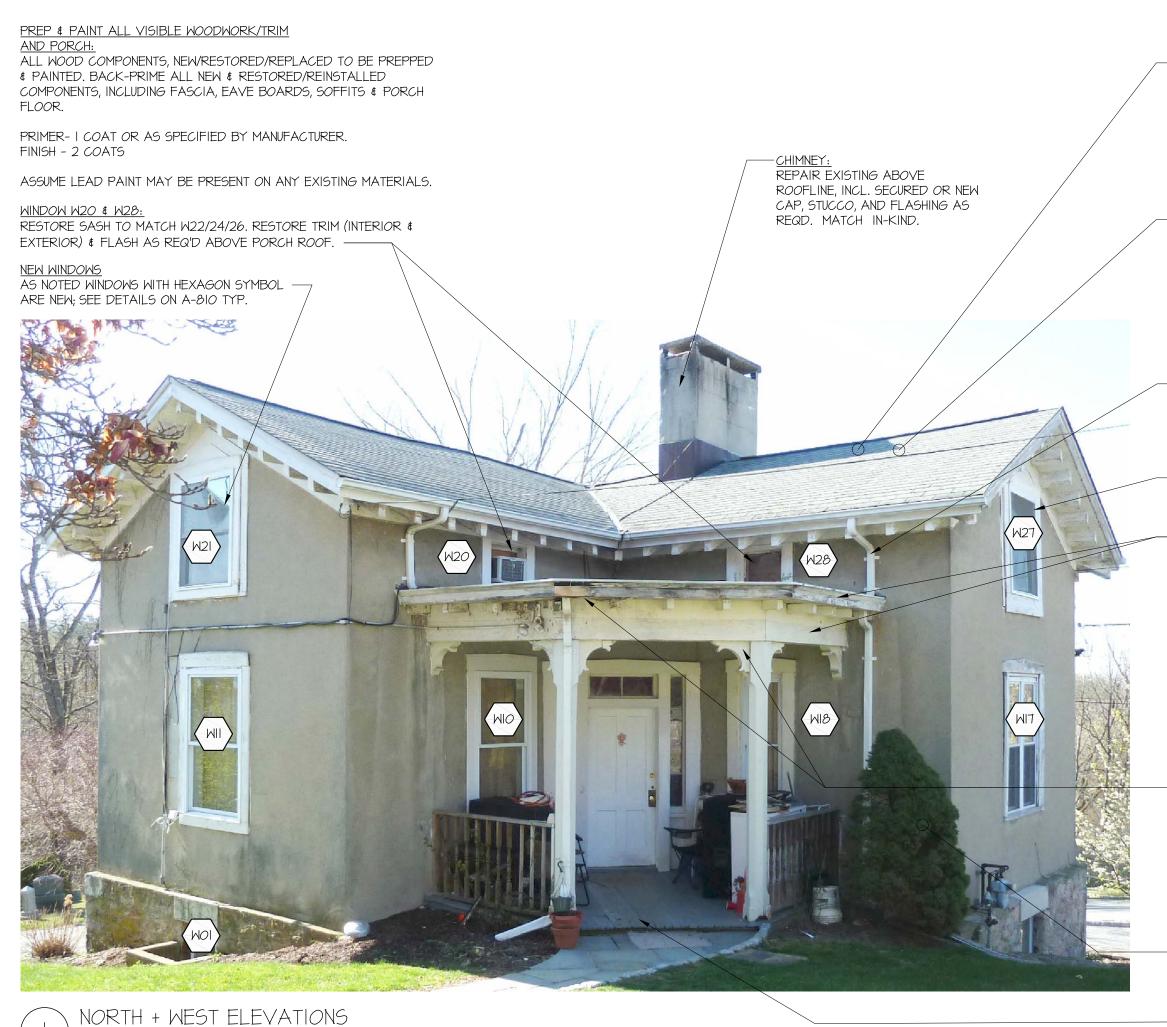

\ SOUTH ELEVATION

PRIMER- I COAT OR AS SPECIFIED BY MANUFACTURER. FINISH - 2 COATS

NORTH AND WEST ELEVATIONS, INCLUDING MUNTINS, NEW TRIM.) ALTERNATE #3: PORCH ROOF UPGRADE UPGRADE THE PORCH ROOF FROM THE BASE SCOPE OF ROLLED ASPHALT TO SOLDERED

FLAT-SEAM, LEAD COATED COPPER.

ALTERNATE NOTES:

ALTERNATE #1: FRONT DOOR

RESTORE THE EXISTING FRONT DOOR,

DOOR HARDWARE. PREP AND PAINT.

INCLUDING TRANSOM AND SIDELITES. REPLACE

PLEXIGLASS LITES WITH CATEGORY I SAFETY

GLASS PER CODE. REPAIR/REPLACE MUNTINS

AS REQUIRED. RETAIN AND CLEAN EXISTING

ALTERNATE #2: ADDITIONAL NEW WINDOWS

REPLACE THE IST. AND 2ND. FLOOR WINDOWS ON THE EAST AND SOUTH ELEVATIONS WITH CUSTOM OR MARVIN WINDOWS. SEE DRAWING A-810. WINDOWS MATCH OR ARE SIMILAR IN

DETAIL TO THOSE OF THE BASE SCOPE ON THE

ALTERNATE #4: MAIN ROOF, ASPHALT SHINGLE REPLACE EXISTING ROOF WITH NEW ASPHALT SHINGLE ROOF, INCLUDING COPPER FLASHING/DRIP EDGE; RESTORE/REPLACE AND PAINT ROOF EAVES, RAFTER TAILS; INSTALL NEW COPPER-PAINTED ALUMINUM 5" HALF-ROUND GUTTERS AND 4" ROUND LEADERS

ALTERNATE #5: MAIN ROOF, METAL PANEL REPLACE EXISTING ROOF WITH NEW ATAS STANDING SEAM METAL PANEL ROOF, INCLUDING COPPER/APPROPRIATE FLASHING/DRIP EDGE; RESTORE/REPLACE AND PAINT ROOF EAVES, RAFTER TAILS; INSTALL NEW COPPER PAINTED ALUMINUM 5" HALF-ROUND GUTTERS AND 4" ROUND LEADERS. CHANGE EXISTING COPPER CHIMNEY FLASHING TO ALUMINUM.

ALTERNATE #6: PAINT ALL STUCCO PAINT ENTIRE STUCCO EXTERIOR ONE COLOR, AS IDENTIFIED BY ARCHITECT.

ALTERNATE #7: CHIMNEY UPGRADE UPGRADE FROM BASE SCOPE OF REBUILDING EXISTING TO MATCHING BRICK WITH CORBELS AS SHOWN IN 1865 IMAGE.


#### GENERAL NOTES:

ALL DIMENSIONS ARE TO NEW ROUGH FRAMING OR TO FINISHED SURFACE OF EXISTING BUILDING UNLESS OTHERWISE NOTED.

2. DO NOT SCALE DRAWINGS. USE WRITTEN DIMENSIONS OR VERIFY WITH ARCHITECT.

. THE CONTRACTOR SHALL VERIFY ALL DIMENSIONS, LAYOUT CONSTRUCTIONS, AND EXISTING CONDITIONS IN THE FIELD AND SHALL NOTIFY THE ARCHITECT OF ANY DISCREPANCIES BEFORE STARTING WORK. A PLUS / MINUS (+/-) INDICATES DIMENSIONS WHICH MAY VARY.

PREP & PAINT ALL VISIBLE WOODWORK/TRIM <u>AND PORCH</u>

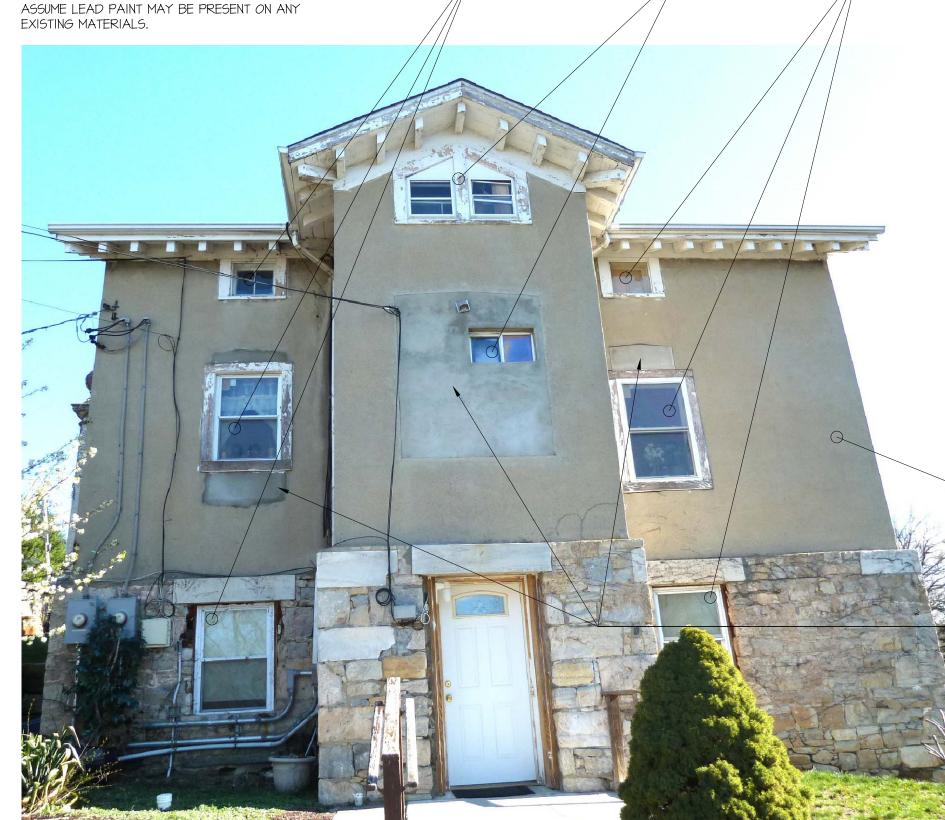

ALTERNATE #4 MAIN ROOF, ASPHALT SHINGLE REPLACE EXISTING ROOF WITH NEW ASPHALT SHINGLE ROOF, INCLUDING COPPER FLASHING/DRIP EDGE; RESTORE/REPLACE AND PAINT ROOF EAVES, RAFTER TAILS; INSTALL NEW COPPER-PAINTED ALUMINUM 5" HALF-ROUND

GUTTERS AND 4" ROUND LEADERS

MAIN ROOF, METAL PANEL
REPLACE EXISTING ROOF WITH NEW ATAS STANDING SEAM METAL PANEL ROOF, INCLUDING COPPER/APPROPRIATE FLASHING/DRIP EDGE; RESTORE/REPLACE AND PAINT ROOF EAVES, RAFTER TAILS; INSTALL NEW COPPER PAINTED ALUMINUM 5" HALF-ROUND GUTTERS AND 4" ROUND LEADERS. CHANGE EXISTING COPPER CHIMNEY FLASHING TO ALUMINUM.

<u>DOWNSPOUTS:</u> REPLACE EXISTING WITH NEW & PLAIN-ROUND DOWNSPOUTS, PAINTED ALUMINUM. NEW WINDOWS

AS NOTED WINDOWS WIITH HEXAGON SYMBOL ARE NEW SEE DETAILS ON A-810 TYP.

PORCH ROOF, FASCIA & CEILING: REPLACE EXISTING ROOF WITH NEW ROLLED ASPHALT ROOFING MEMBRANE. INCREASE SLOPE OF ROOF, INSERT

COPPER FLASHING AT WALL & BENEATH WINDOW SILLS, & PATCH STUCCO AS REPLACE EXISTING RAFTERS, FASCIA, SOFFIT, BEAM, BUILT-IN GUTTER & CEILING AS REQD.

PORCH COLUMNS, RAFTER TAILS & BRACKETS: RESTORE (2) EXISTING COLUMNS, RAFTER TAILS & BRACKETS. ASSUME RAFTER TAILS TO BE

REPLACED IN-KIND.

LTERNATE #6 PAINT ENTIRE STUCCO EXTERIOR ONE COLOR, AS IDENTIFIED BY ARCHITECT.

REPLACE EXISTING WITH NEW 3 ½"X IPE WOOD DECKING TO MATCH EXISTING, WITH AZEK APRON. REPAIR/REPLACE FLOOR JOISTS AS REQ'D. ASSUME 80% REPLACEMENT.

ALTERNATE #2 ADDITIONAL NEW WINDOWS REPLACE THE IST. AND 2ND. FLOOR WINDOWS ON THE EAST AND SOUTH ELEVATIONS WITH CUSTOM OR MARVIN WINDOWS. SEE DRAWING A-810. WINDOWS MATCH OR ARE SIMILAR IN DETAIL TO THOSE OF THE BASE SCOPE ON THE NORTH AND WEST ELEVATIONS, INCLUDING MUNTINS, NEW TRIM.)

ALTERNATE #4 MAIN ROOF, ASPHALT SHINGLE REPLACE EXISTING ROOF WITH NEW ASPHALT SHINGLE ROOF, INCLUDING COPPER FLASHING/DRIP EDGE; RESTORE/REPLACE AND PAINT ROOF EAVES, RAFTER TAILS; INSTALL NEW COPPER-PAINTED ALUMINUM 5" HALF-ROUND GUTTERS AND 4" ROUND LEADERS

MAIN ROOF, METAL PANEL REPLACE EXISTING ROOF WITH NEW ATAS STANDING SEAM METAL PANEL ROOF, INCLUDING COPPER/APPROPRIATE FLASHING/DRIP EDGE; RESTORE/REPLACE AND PAINT ROOF EAVES, RAFTER TAILS; INSTALL NEW COPPER PAINTED ALUMINUM 5" HALF-ROUND GUTTERS AND 4" ROUND LEADERS. CHANGE EXISTING COPPER CHIMNEY FLASHING TO ALUMINUM.

ALTERNATE #6 PAINT ALL STUCCO PAINT ENTIRE STUCCO EXTERIOR ONE COLOR, AS IDENTIFIED BY ARCHITECT.

TYPICAL EXISTING CONDITION: PATCH STUCCO TO MATCH EXISTING



ALTERNATE #7

UPGRADE FROM BASE SCOPE

OF REBUILDING EXISTING TO

CORBELS AS SHOWN IN 1865

MATCHING BRICK WITH

- TYPICAL EXISTING CONDITION: PATCH STUCCO TO MATCH EXISTING

> -REPLACE MARBLE LINTEL: PROVIDE NEW STONE LINTEL MATCH EXISTING

T.O. SECOND FL.

T.O. GROUND FL.

01 09-09-2019 ENTIRE SET No. Date Description

STEPHEN TILLY,

Architect

22 Elm Street

Dobbs Ferry, New York 10522

Tel: (914) 693-8898 Fax 693-4235

email: office@stillyarchitect.com

Revisions:

Sept 09, 2019 Issued for Town Review April 12, 2019 Issued for Town Review

**Issued For** 

**Submissions:** 

Project: SUPERINTENDENT'S COTTAGE DALE CEMETERY OSSINING, NY


Date: April 12, 2019

NEW CONSTRUCTION **ELEVATIONS** 


Scale: As Noted

Drawn by: sy, sr, da, sos

NEW CONSTRUCTION **ELEVATIONS** 

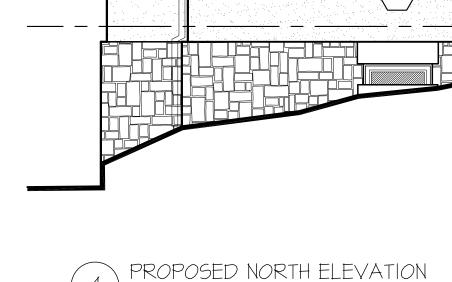

EAST ELEVATION

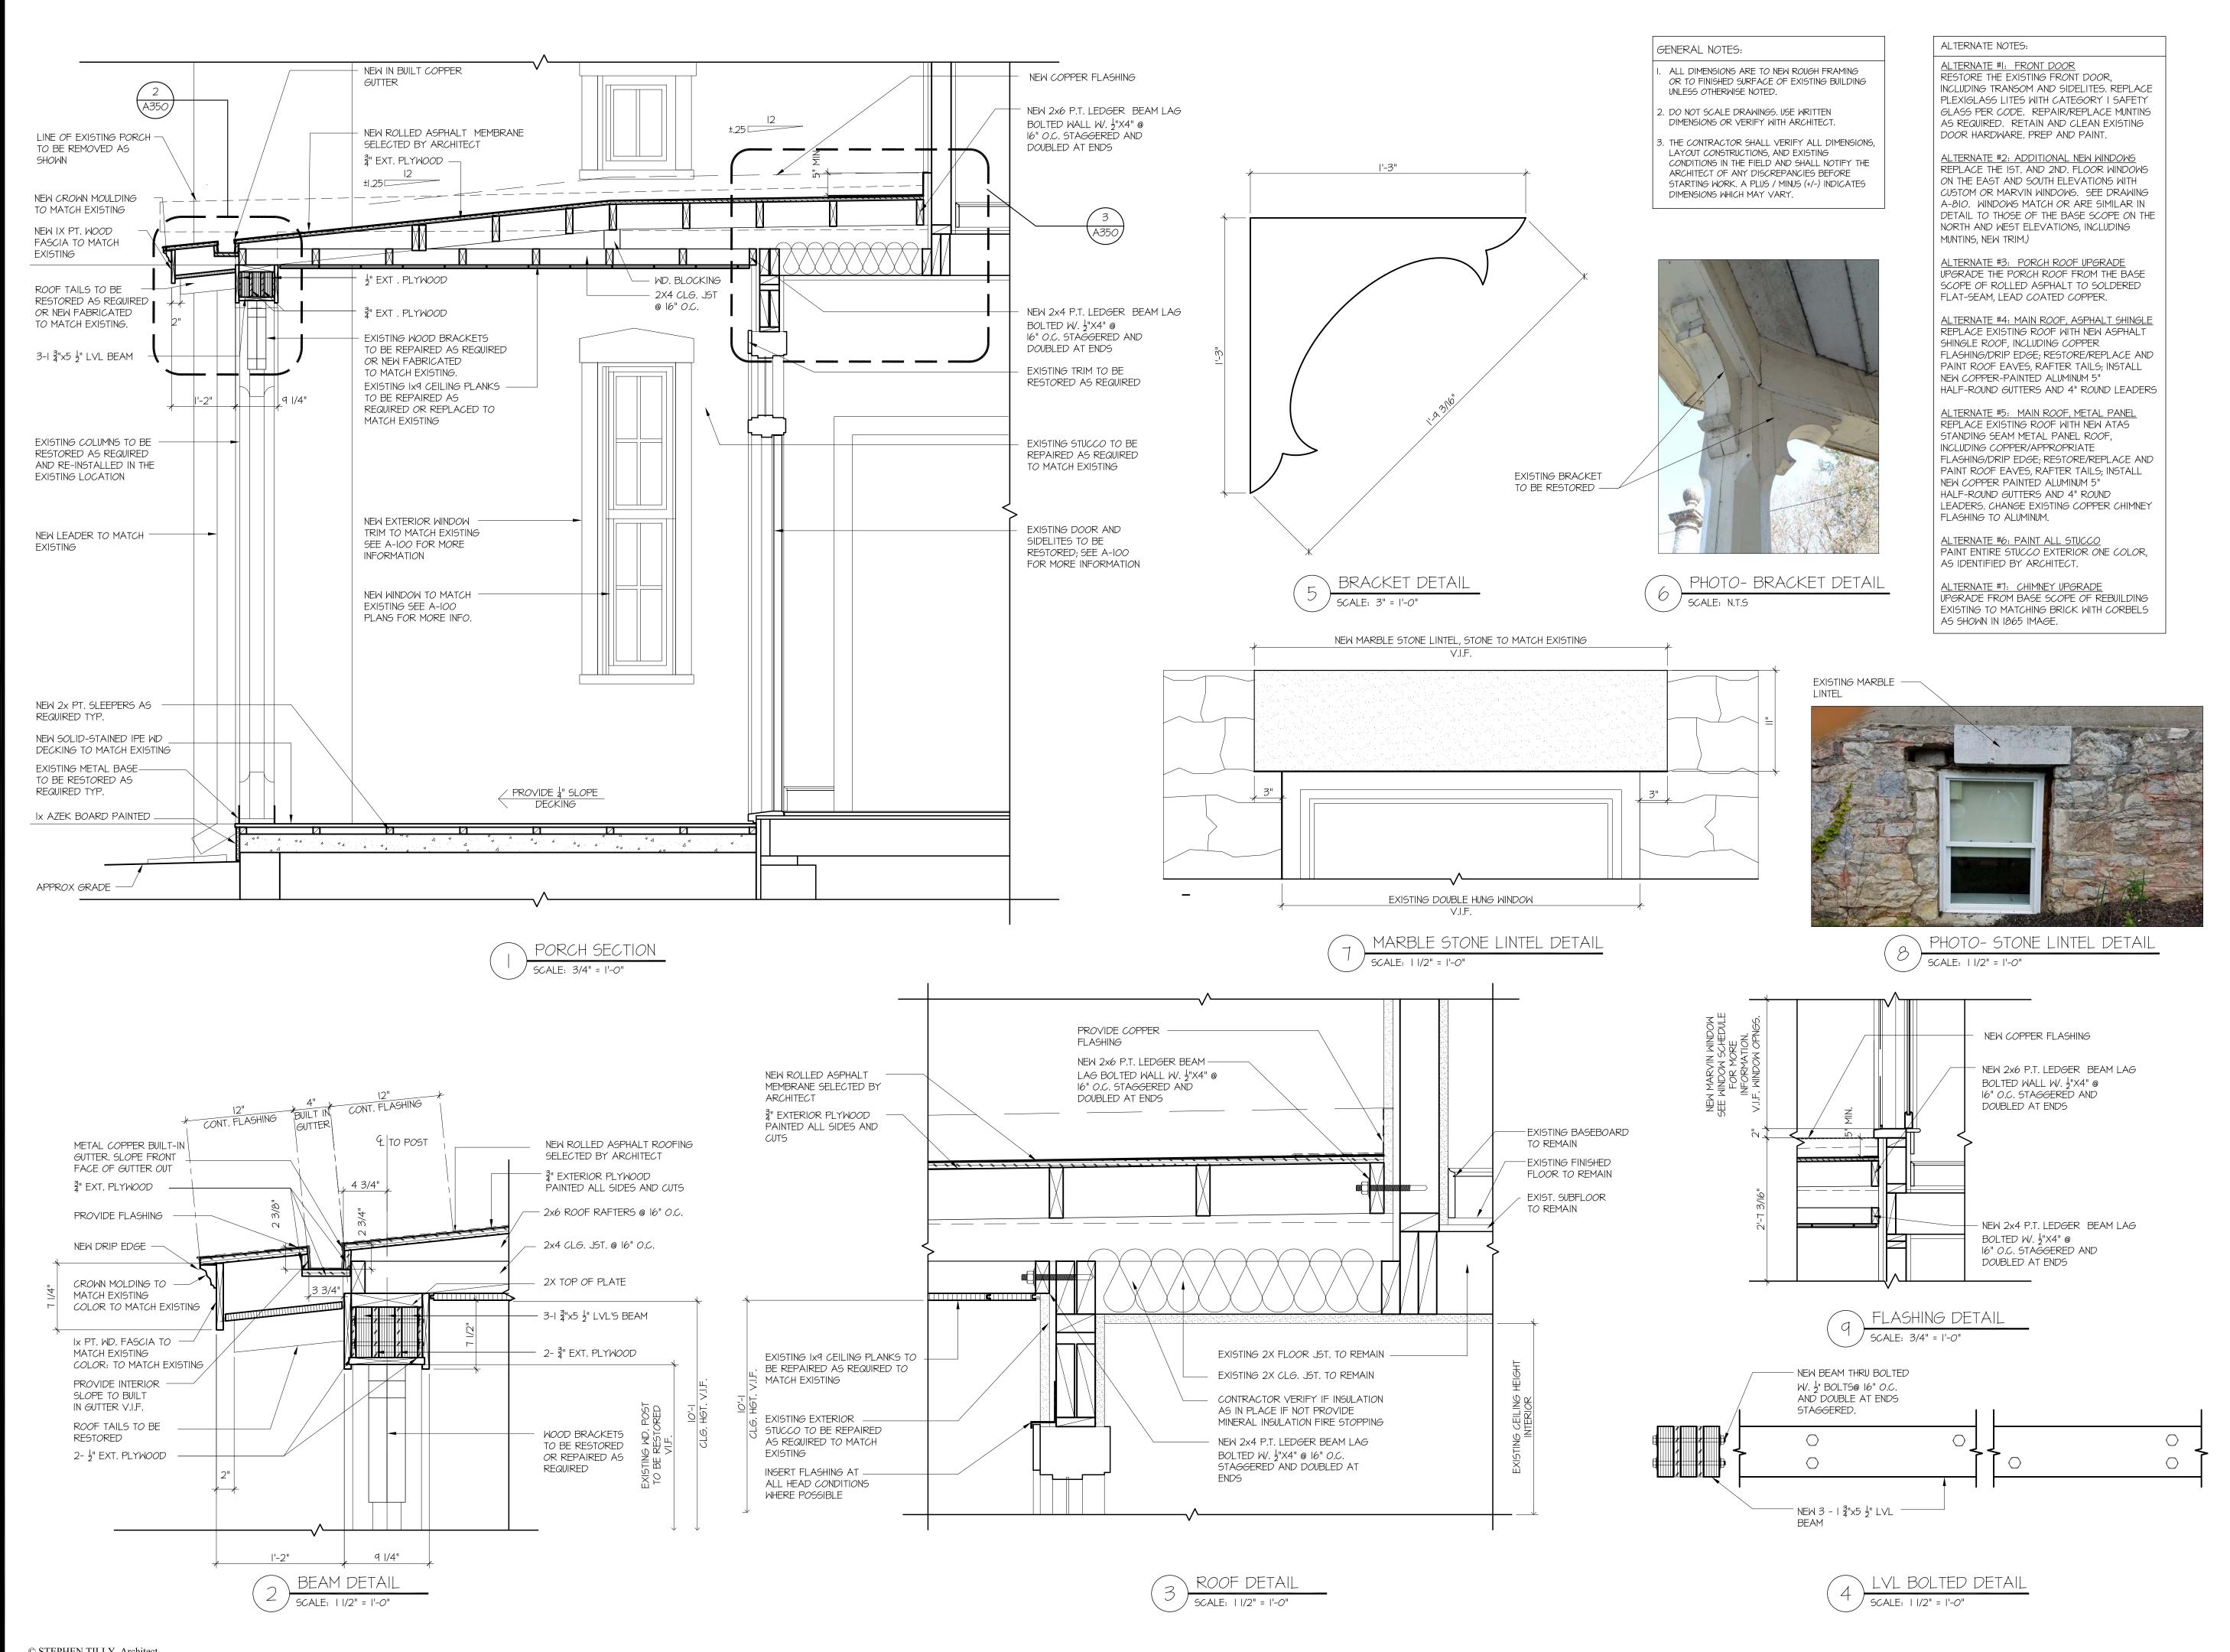

#### STEPHEN TILLY, Architect

22 Elm Street Dobbs Ferry, New York 10522 Tel: (914) 693-8898 Fax 693-4235 email: office@stillyarchitect.com

01 09-09-2019 ENTIRE SET No. Date Description Revisions:

Sept 09, 2019 Issued for Town Review April 12, 2019 Issued for Town Review Issued For

**Submissions:** 


Project: SUPERINTENDENT'S COTTAGE DALE CEMETERY OSSINING, NY

April 12, 2019 Date: PORCH SECTION &

**DETAILS** 

Scale: As Noted Drawn by: sy, sr, da, sos

PORCH SECTION & DETAILS

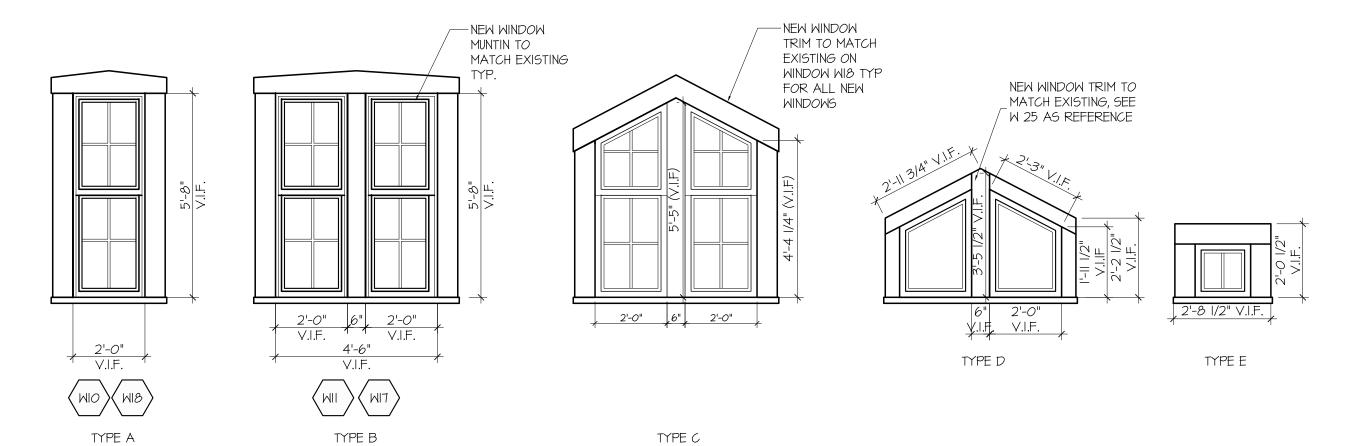

NEW WINDOWS MAIN SCOPE

SEE WINDOW SCHEDULE FOR

- MORE INFORMATION

NEW WINDOWS ALTERNATE #2

NEW WINDOWS ALTERNATE #2 SEE WINDOW SCHEDULE FOR MORE INFORMATION

SEE MINDOM SCHEDULE FOR MORE INFORMATION


W--ALT

WINDOWS ELEVATIONS SCALE: 3/8" = 1'-0"




NORTH + WEST ELEVATIONS



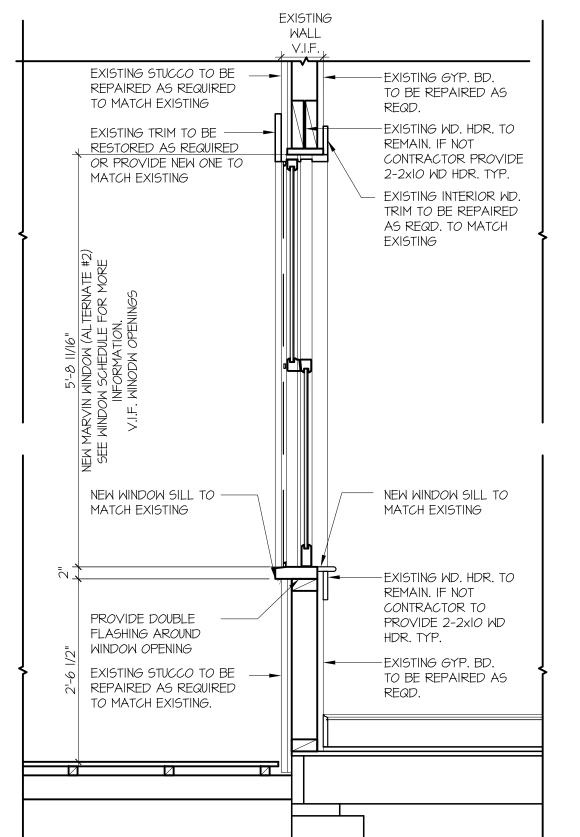

WINDOWS ELEVATION / SECTION TYP.

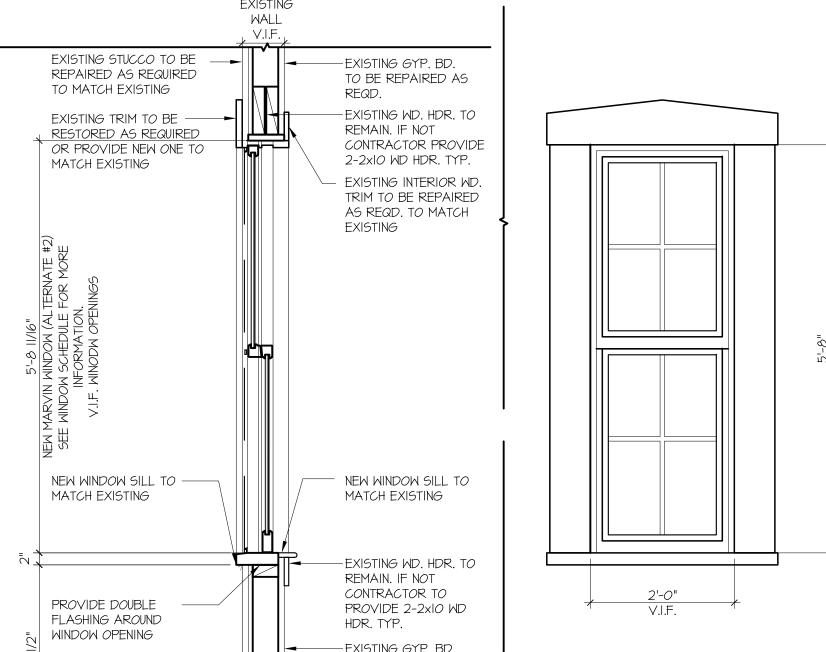

ALTERNATE NOTES:

ALTERNATE #I: FRONT DOOR RESTORE THE EXISTING FRONT DOOR, INCLUDING TRANSOM AND SIDELITES. REPLACE PLEXIGLASS LITES WITH CATEGORY I SAFETY GLASS PER CODE. REPAIR/REPLACE MUNTINS AS REQUIRED. RETAIN AND CLEAN EXISTING DOOR HARDWARE. PREP AND PAINT.

ALTERNATE #2: ADDITIONAL NEW WINDOWS REPLACE THE IST. AND 2ND. FLOOR WINDOWS ON THE EAST AND SOUTH ELEVATIONS WITH CUSTOM OR MARVIN WINDOWS. SEE DRAWING A-810. WINDOWS MATCH OR ARE SIMILAR IN DETAIL TO THOSE OF THE BASE SCOPE ON THE NORTH AND WEST ELEVATIONS, INCLUDING MUNTINS, NEW TRIM.)

ALTERNATE #3: PORCH ROOF UPGRADE UPGRADE THE PORCH ROOF FROM THE BASE SCOPE OF ROLLED ASPHALT TO SOLDERED FLAT-SEAM, LEAD COATED COPPER.

ALTERNATE #4: MAIN ROOF, ASPHALT SHINGLE REPLACE EXISTING ROOF WITH NEW ASPHALT SHINGLE ROOF, INCLUDING COPPER FLASHING/DRIP EDGE; RESTORE/REPLACE AND PAINT ROOF EAVES, RAFTER TAILS, INSTALL NEW COPPER-PAINTED ALUMINUM 5" HALF-ROUND GUTTERS AND 4" ROUND LEADERS

ALTERNATE #5: MAIN ROOF, METAL PANEL REPLACE EXISTING ROOF WITH NEW ATAS STANDING SEAM METAL PANEL ROOF, INCLUDING COPPER/APPROPRIATE FLASHING/DRIP EDGE; RESTORE/REPLACE AND PAINT ROOF EAVES, RAFTER TAILS; INSTALL NEW COPPER PAINTED ALUMINUM 5" HALF-ROUND GUTTERS AND 4" ROUND LEADERS. CHANGE EXISTING COPPER CHIMNEY FLASHING TO ALUMINUM.

ALTERNATE #6: PAINT ALL STUCCO PAINT ENTIRE STUCCO EXTERIOR ONE COLOR, AS IDENTIFIED BY ARCHITECT.

ALTERNATE #7: CHIMNEY UPGRADE UPGRADE FROM BASE SCOPE OF REBUILDING EXISTING TO MATCHING BRICK WITH CORBELS AS SHOWN IN 1865 IMAGE.

GENERAL NOTES:

ALL DIMENSIONS ARE TO NEW ROUGH FRAMING OR TO FINISHED SURFACE OF EXISTING BUILDING UNLESS OTHERWISE NOTED.

2. DO NOT SCALE DRAWINGS. USE WRITTEN DIMENSIONS OR VERIFY WITH ARCHITECT.

3. THE CONTRACTOR SHALL VERIFY ALL DIMENSIONS, LAYOUT CONSTRUCTIONS, AND EXISTING CONDITIONS IN THE FIELD AND SHALL NOTIFY THE ARCHITECT OF ANY DISCREPANCIES BEFORE STARTING WORK. A PLUS / MINUS (+/-) INDICATES DIMENSIONS WHICH MAY VARY.



SOUTH ELEVATION



EAST ELEVATION SCALE: N/A

	MINDO	OW SCHE	WINDOW TAG SYMBOL (M)					
FLOOR	TYPE	WINDOW DESCRIPTION		UNIT	OPENING	TRIM	NOTES	
BASEMENT	MOI	MOI	HALF-UNDERGROUND, WELL	NEW SASH (EXTG = BROKEN)	2'-0 ½"x2'-10 ½" MASONRY OPGN. V.I.F.	EXTERIOR - N/A INTERIOR TO MATCH EXIST.	I WINDOW	
	А	MIO	2-4/4 DOUBLE-HUNG SASH	NEW DOUBLE-HUNG, W/ MUNTINS	2'-2 g"x5'-5 ½" FRAMING OPENING V.I.F.	NEW TO MATCH EXISTING USE WIØ FOR TEMPLATE	I WINDOW	
GROUND FLOOR	В	MII	2-4/4 DOUBLE-HUNG SASH	NEW PAIR DOUBLE HUNG	$2'-2\frac{3}{8}"x5'-5\frac{1}{2}"$ FRAMING OPENING V.I.F.	NEW TO MATCH EXISTING USE WIS FOR TEMPLATE NEW	2 WINDOW	
GROUNE	В	WI7	2-4/4 DOUBLE-HUNG SASH	NEW PAIR DOUBLE HUNG	$2'-2\frac{3}{8}"x5'-5\frac{1}{2}"$ FRAMING OPENING V.I.F.	NEW TO MATCH EXISTING USE WIØ FOR TEMPLATE	2 WINDOW	
	Α	MIB	2-4/4 DOUBLE-HUNG SASH	NEW DOUBLE-HUNG SASH - MUNTIN	$2'-2\frac{3}{8}"x5'-5\frac{1}{2}"$ FRAMING OPENING V.I.F.	EXIST. EXTERIOR	* ORIGINAL SIZE & EXTER. TRIM	
N.	E	W2 <i>0</i>	I/I PLEXIGLASS PANEL	RESTORE EXIST. CASEMENT OR RECONSTRUCTECT	I'-9"xI'-7 &" FRAMING OPENING V.I.F.	NEW TO MATCH EXISTING USE WIS FOR TEMPLATE NEW	* ORIGINAL OPENING & TRIM	
SECOND FLOOR	С	W2I	2-4/4 DOUBLE-HUNG SASH	NEW PAIR DOUBLE HUNG	CUSTOM WINDOW V.I.F.	TO MATCH EXISTING USE WIB FOR TEMPLATE	2 WINDOW	
SECONI	С	W27	2-4/4 DOUBLE-HUNG SASH	NEW PAIR DOUBLE HUNG	CUSTOM WINDOW V.I.F.	NEW TO MATCH EXISTING USE WIØ FOR TEMPLATE	2 WINDOW	
	E	W28	I/I PLEXIGLASS PANEL	RESTORE EXIST. CASEMENT OR RECONSTRUCTECT	I'-9"xI'-7 &" FRAMING OPENING V.I.F.	NEW TO MATCH EXISTING USE WIØ FOR TEMPLATE	* ORIGINAL OPENING & TRIM	

EXISTING ORIGINAL DOUBLE HUNG & CASEMENT SASH AT #W20, W28 & W23 (NORTHERN) TO BE USED AS TEMPLATES (MUNTINS, STILE) FOR RECONSTRUCTION OF NEW SASH; ALL GLAZING SUPPLIED TO MEET CODE.

	WINDO	WINDOW TAG SYMBOL (W					
FL <i>oo</i> r	TYPE	WINDOW TAG	DESCRIPTION	UNIT	OPENING	TRIM	NOTES
	А	WO2	2-4/4 DOUBLE-HUNG SASH	NEW DOUBLE-HUNG, W/ MUNTINS	2'-0 ½"x3'-10 ½" MANSORY OPNG. V.I.F.	EXTERIOR - N/A INTERIOR TO MATCH EXISTING	I WINDOW
MENT	А	W03	2-4/4 DOUBLE-HUNG SASH	NEW DOUBLE-HUNG, W/ MUNTINS	2'-0 ½"x3'-10 ½" MANSORY OPNG. V.I.F.	EXTERIOR - N/A INTERIOR TO MATCH EXISTING	I WINDOW
BASEMENT	А	WO4	2-4/4 DOUBLE-HUNG SASH	NEW DOUBLE-HUNG, W/ MUNTINS	2'-0 ½"x3'-10 ½" MANSORY OPNG. V.I.F.	EXTERIOR - N/A INTERIOR TO MATCH EXISTING	I WINDOW
	А	WO5	2-4/4 DOUBLE-HUNG SASH	NEW DOUBLE-HUNG, W/ MUNTINS	2'-0 ½"x3'-10 ½" MANSORY OPNG. V.I.F.	EXTERIOR - N/A INTERIOR TO MATCH EXISTING	I WINDOW
	Α	W06	2-4/4 DOUBLE-HUNG SASH	NEW DOUBLE-HUNG, W/ MUNTINS	2'-8 ½"X3'-6 ½" MANSORY OPNG. V.I.F.	EXTERIOR - N/A INTERIOR TO MATCH EXISTING	I WINDOW
	А	WI2	2-4/4 DOUBLE-HUNG SASH W/ A/C	NEW DOUBLE-HUNG, W/ MUNTINS	2'-2 g"x5'-5 ½" FRAMING OPENING V.I.F.	NEW TO MATCH EXISTING USE WIB FOR TEMPLATE	I WINDOW
20R	В	WI3 STAIR	2-4/4 DOUBLE-HUNG SASH	NEW DOUBLE-HUNG, W/ MUNTINS	2'-2 g"x5'-5 ½" FRAMING OPENING V.I.F.	NEW TO MATCH EXISTING USE WIØ FOR TEMPLATE	2 WINDOWS
SROUND FLOOR	А	WI4	2-4/4 DOUBLE-HUNG SASH	NEW DOUBLE-HUNG, W/ MUNTINS	2'-2 g"x5'-5 ½" FRAMING OPENING V.I.F.	NEW TO MATCH EXISTING USE WIØ FOR TEMPLATE	I WINDOW
GRC	В	WI5 BATH	2-4/4 DOUBLE-HUNG SASH	NEW DOUBLE-HUNG, W/ MUNTINS	2'-2 g"x5'-5 ½" FRAMING OPENING V.I.F.	NEW TO MATCH EXISTING USE WIB FOR TEMPLATE	2 WINDOWS
	Α	WI6 KITCHEN	2-4/4 DOUBLE-HUNG SASH	NEW DOUBLE-HUNG, W/ MUNTINS	2'-2 3"x5'-5 ½" FRAMING OPENING V.I.F.	NEW TO MATCH EXISTING USE WIB FOR TEMPLATE	I WINDOW
	E	W22	CASEMENT W/ 2 LIGHTS COVERED BY CASEMENT W/   LITE	NEW CASEMENT	I'-9"xI'-7 है" FRAMING OPENING V.I.F.	NEW TO MATCH EXISTING USE WIØ FOR TEMPLATE	I WINDOW
SECOND FLOOR	С	W23 UPPER STAIR	2-4/4 LARGE DOUBLE-HUNG SASH; (I) SMALL I/I DOUBLE-HUNG COVERING THE OLD WINDOW ??	NEW DOUBLE-HUNG, W/ MUNTINS CUSTOM	CUSTOM WINDOW V.I.F.	NEW TO MATCH EXISTING USE WIØ FOR TEMPLATE	2 WINDOWS
	E	W24	CASEMENT W/ 2 LIGHTS COVERED BY CASEMENT W/   LITE ??	NEW CASEMENT	I'-9"xI'-7 \$" FRAMING OPENING V.I.F.	NEW TO MATCH EXISTING USE WIB FOR TEMPLATE	I WINDOW
•	D	W25	2-4/4 CASEMENT SASH	NEW DOUBLE-HUNG, W/ MUNTINS CUSTOM	CUSTOM WINDOW V.I.F.	NEW TO MATCH EXISTING USE WIØ FOR TEMPLATE	2 WINDOWS
	E	W26	CASEMENT W/ 2 LIGHTS COVERED BY CASEMENT W/ I LITE??	NEW CASEMENT	I'-9"xI'-7 } FRAMING OPENING V.I.F.	NEW TO MATCH EXISTING USE WIB FOR TEMPLATE	I WINDOW

#### STEPHEN TILLY, Architect

22 Elm Street Dobbs Ferry, New York 10522 Tel: (914) 693-8898 Fax 693-4235 email: office@stillyarchitect.com

01 09-09-2019 ENTIRE SET No. Date Description

Revisions:

Sept 09, 2019 Issued for Town Review April 12, 2019 Issued for Town Review

**Issued For** 

Project: SUPERINTENDENT'S COTTAGE DALE CEMETERY OSSINING, NY

April 12, 2019 WINDOW SCHEDULE

AND DETAILS

Scale: As Noted

Drawn by: sy, sr, da, sos

WINDOW SCHEDULE AND DETAILS