
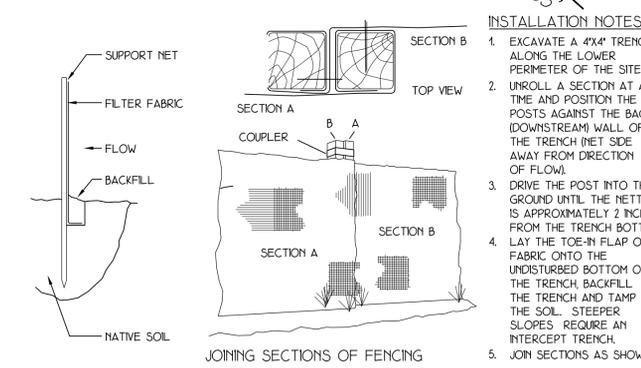


IT IS A VIOLATION OF THE LAW FOR ANY PERSON, UNLESS ACTING UNDER THE DIRECTION OF A LICENSED ARCHITECT, TO ALTER AN ITEM IN ANY WAY. IF AN ITEM BEARING THE SEAL OF AN ARCHITECT IS ALTERED, THE ALTERING ARCHITECT SHALL AFFIX TO THIS ITEM THE SEAL AND THE NOTATION "ALTERED BY FOLLOWED BY HIS/HER SIGNATURE AND THE DATE OF SUCH ALTERATION, AND A SPECIFIC DESCRIPTION OF THE ALTERATION."

REV.	DATE	COMMENT
1	11-11-19	AS PER BLDG. DEP
2	04-24-20	ZONING CHART
3	05-18-20	AS PER PLAN. BD.
4	05-29-20	AS PER PLAN. BD.
5	06-04-20	AS PER PLAN. BD.
6	06-18-20	AS PER ARB
7	07-08-20	AS PER ARB

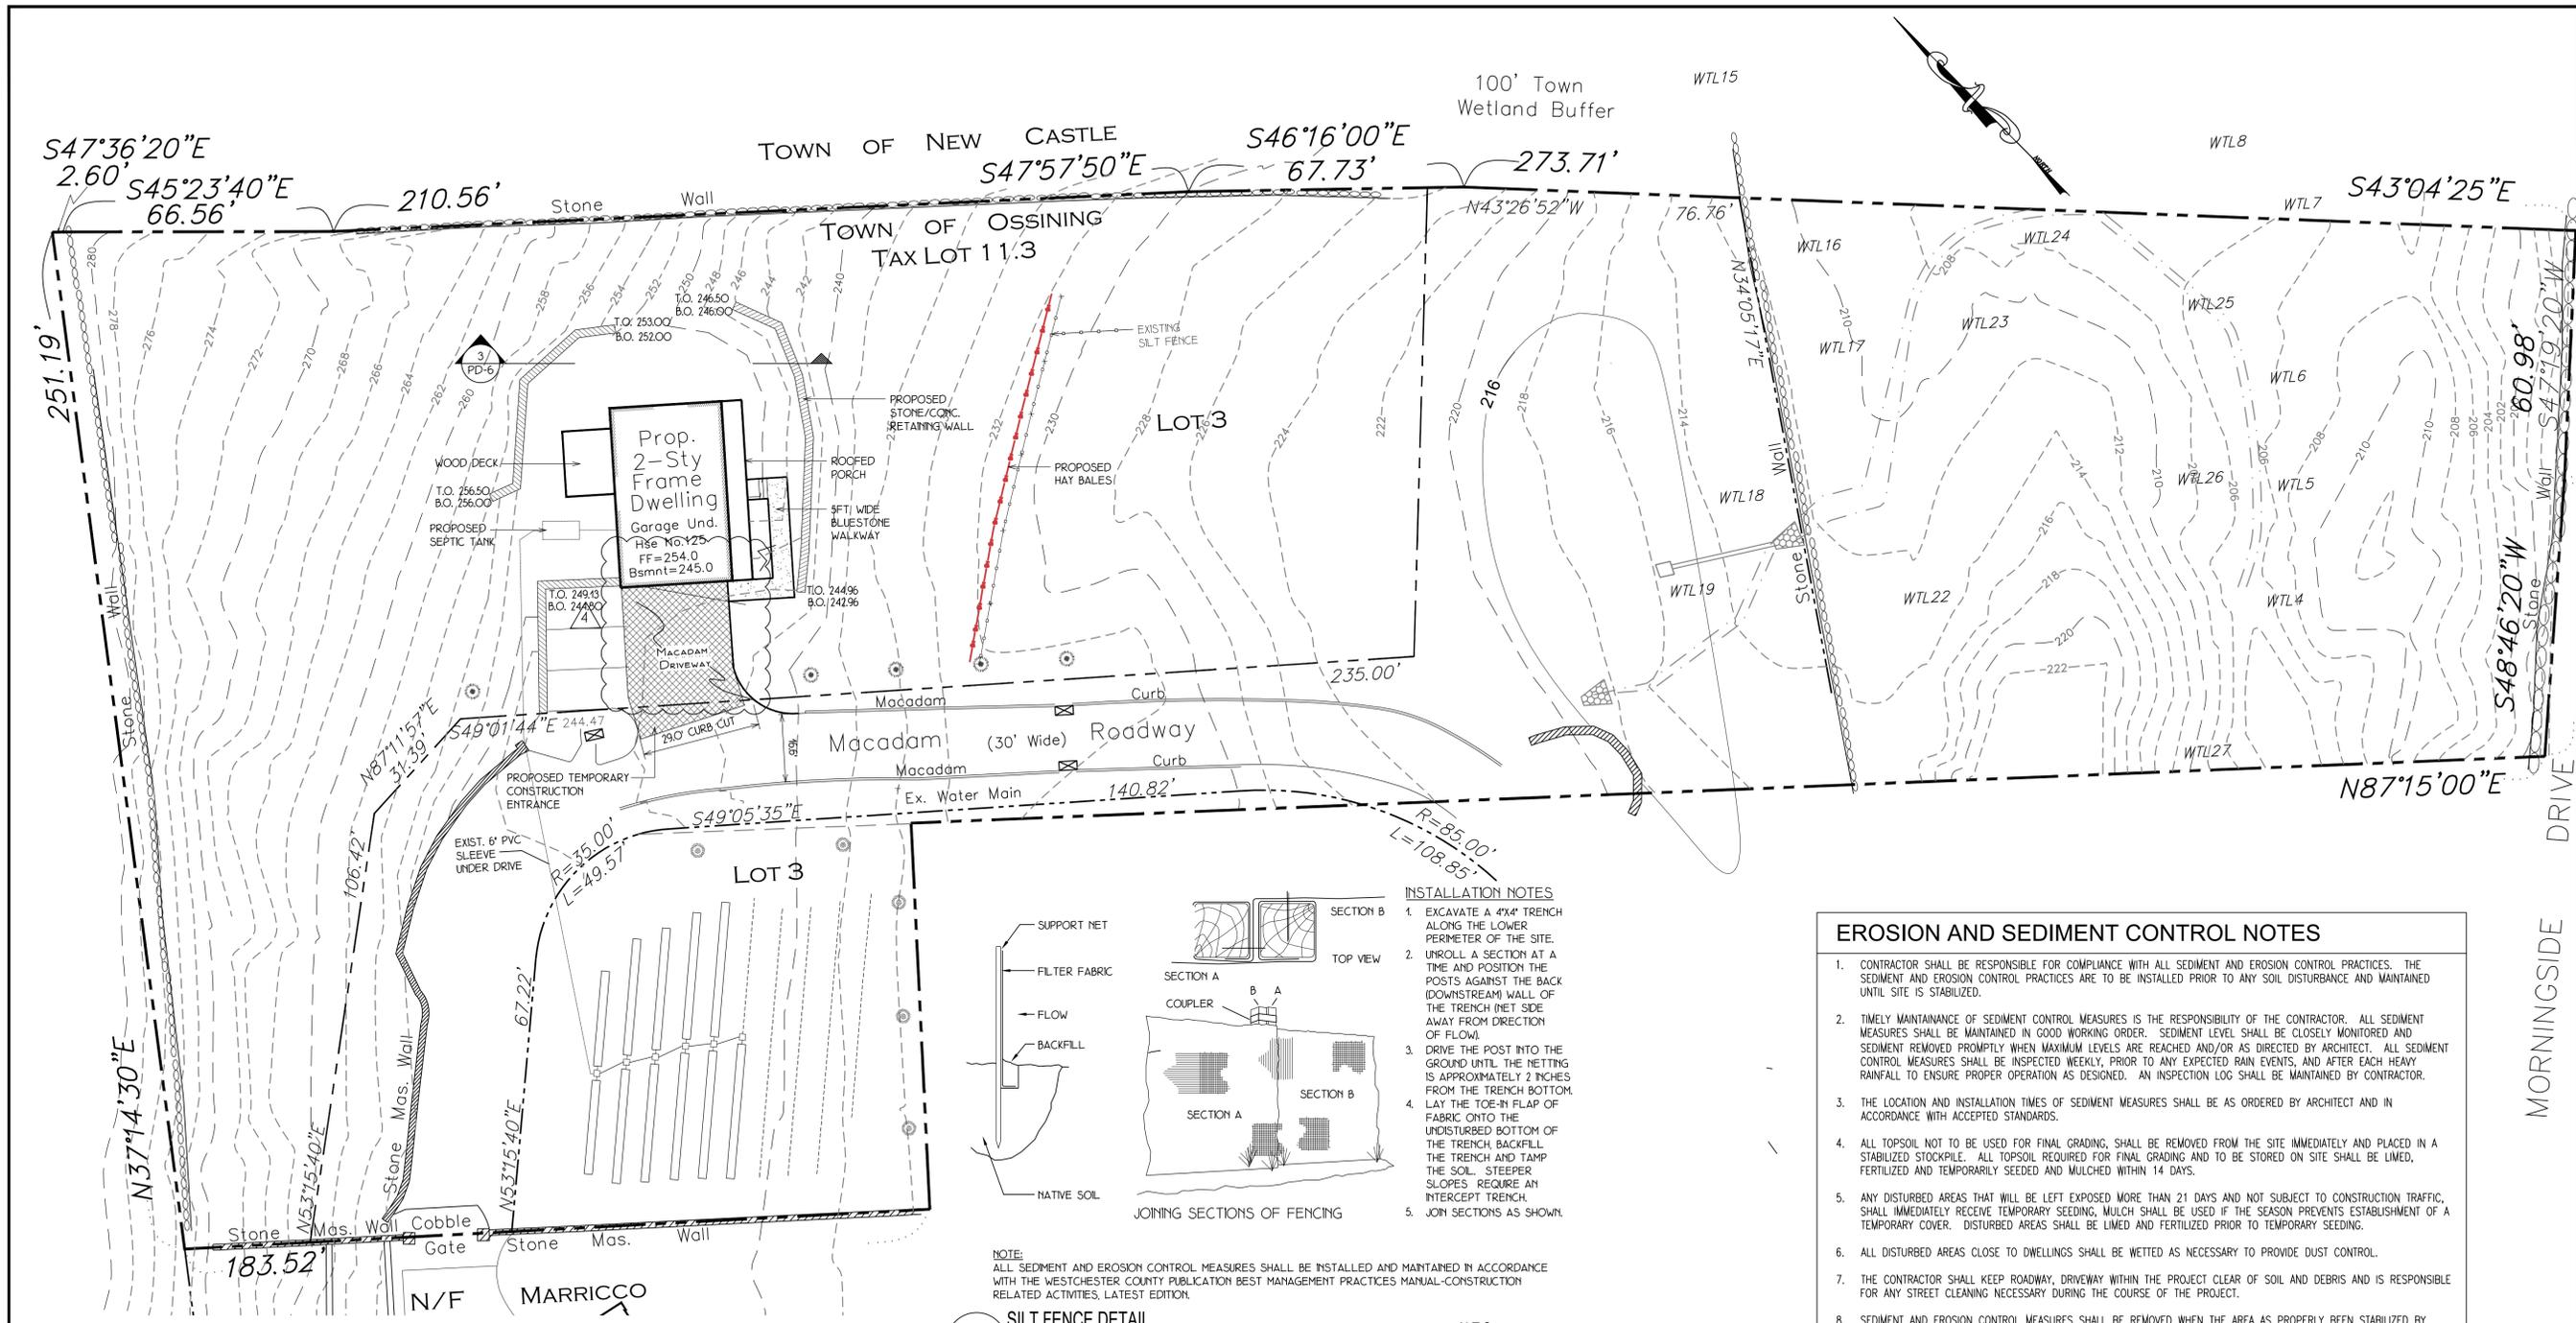


**INSTALLATION NOTES**

- EXCAVATE A 4"x4" TRENCH ALONG THE LOWER PERIMETER OF THE SITE.
- UNROLL A SECTION AT A TIME AND POSITION THE POSTS AGAINST THE BACK (DOWNSTREAM) WALL OF THE TRENCH (NET SIDE AWAY FROM DIRECTION OF FLOW).
- DRIVE THE POST INTO THE GROUND UNTIL THE NETTING IS APPROXIMATELY 2 INCHES FROM THE TRENCH BOTTOM.
- LAY THE TOE-IN FLAP OF FABRIC ONTO THE UNDISTURBED BOTTOM OF THE TRENCH, BACKFILL THE TRENCH AND TAMP THE SOL. STEEPER SLOPES REQUIRE AN INTERCEPT TRENCH.
- JOIN SECTIONS AS SHOWN.

**EROSION AND SEDIMENT CONTROL NOTES**

- CONTRACTOR SHALL BE RESPONSIBLE FOR COMPLIANCE WITH ALL SEDIMENT AND EROSION CONTROL PRACTICES. THE SEDIMENT AND EROSION CONTROL PRACTICES ARE TO BE INSTALLED PRIOR TO ANY SOIL DISTURBANCE AND MAINTAINED UNTIL SITE IS STABILIZED.
- TIMELY MAINTENANCE OF SEDIMENT CONTROL MEASURES IS THE RESPONSIBILITY OF THE CONTRACTOR. ALL SEDIMENT MEASURES SHALL BE MAINTAINED IN GOOD WORKING ORDER. SEDIMENT LEVEL SHALL BE CLOSELY MONITORED AND SEDIMENT REMOVED PROMPTLY WHEN MAXIMUM LEVELS ARE REACHED AND/OR AS DIRECTED BY ARCHITECT. ALL SEDIMENT CONTROL MEASURES SHALL BE INSPECTED WEEKLY, PRIOR TO ANY EXPECTED RAIN EVENTS, AND AFTER EACH HEAVY RAINFALL TO ENSURE PROPER OPERATION AS DESIGNED. AN INSPECTION LOG SHALL BE MAINTAINED BY CONTRACTOR.
- THE LOCATION AND INSTALLATION TIMES OF SEDIMENT MEASURES SHALL BE AS ORDERED BY ARCHITECT AND IN ACCORDANCE WITH ACCEPTED STANDARDS.
- ALL TOPSOIL NOT TO BE USED FOR FINAL GRADING, SHALL BE REMOVED FROM THE SITE IMMEDIATELY AND PLACED IN A STABILIZED STOCKPILE. ALL TOPSOIL REQUIRED FOR FINAL GRADING AND TO BE STORED ON SITE SHALL BE LIMED, FERTILIZED AND TEMPORARILY SEEDED AND MULCHED WITHIN 14 DAYS.
- ANY DISTURBED AREAS THAT WILL BE LEFT EXPOSED MORE THAN 21 DAYS AND NOT SUBJECT TO CONSTRUCTION TRAFFIC, SHALL IMMEDIATELY RECEIVE TEMPORARY SEEDING, MULCH SHALL BE USED IF THE SEASON PREVENTS ESTABLISHMENT OF A TEMPORARY COVER. DISTURBED AREAS SHALL BE LIMED AND FERTILIZED PRIOR TO TEMPORARY SEEDING.
- ALL DISTURBED AREAS CLOSE TO DWELLINGS SHALL BE WETTED AS NECESSARY TO PROVIDE DUST CONTROL.
- THE CONTRACTOR SHALL KEEP ROADWAY, DRIVEWAY WITHIN THE PROJECT CLEAR OF SOIL AND DEBRIS AND IS RESPONSIBLE FOR ANY STREET CLEANING NECESSARY DURING THE COURSE OF THE PROJECT.
- SEDIMENT AND EROSION CONTROL MEASURES SHALL BE REMOVED WHEN THE AREA AS PROPERLY BEEN STABILIZED BY PERMANENT MEASURES.
- SOIL SEEDING AND FERTILIZING SHALL BE PERFORMED IN ACCORDANCE WITH THE CURRENT EDITION OF "NEW YORK GUIDELINES FOR URBAN EROSION AND SEDIMENT CONTROL."
- ALL SEDIMENT AND EROSION CONTROL MEASURES SHALL BE INSTALLED IN ACCORDANCE WITH THE CURRENT EDITION OF "NEW YORK GUIDELINES FOR URBAN EROSION AND SEDIMENT CONTROL."


**3 SILT FENCE DETAIL N.T.S.**

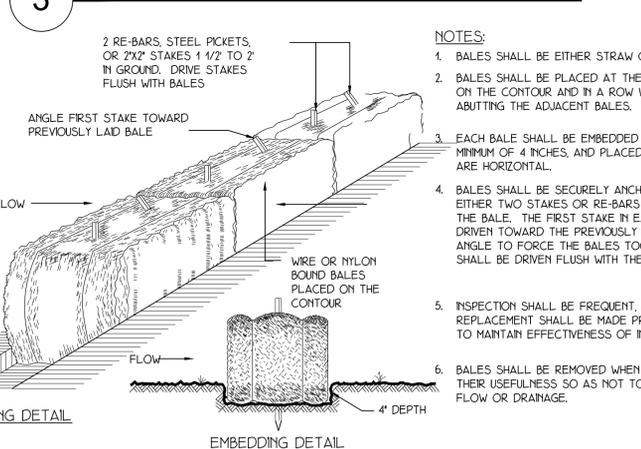

**NOTES:**

- BALES SHALL BE EITHER STRAW OR HAY.
- BALES SHALL BE PLACED AT THE TOE OF SLOPE OR ON THE CONTOUR AND IN A ROW WITH ENDS TIGHTLY ABUTTING THE ADJACENT BALES.
- EACH BALE SHALL BE EMBEDDED IN THE SOIL A MINIMUM OF 4 INCHES, AND PLACED SO THE BINDINGS ARE HORIZONTAL.
- BALES SHALL BE SECURELY ANCHORED IN PLACE BY EITHER TWO STAKES OR RE-BARS DRIVEN THROUGH THE BALE. THE FIRST STAKE IN EACH BALE SHALL BE DRIVEN TOWARD THE PREVIOUSLY LAID BALE AT AN ANGLE TO FORCE THE BALES TOGETHER. STAKES SHALL BE DRIVEN FLUSH WITH THE BALE.
- INSPECTION SHALL BE FREQUENT, AND REPAIR AND/OR REPLACEMENT SHALL BE MADE PROMPTLY AS NEEDED TO MAINTAIN EFFECTIVENESS OF INSTALLATION.
- BALES SHALL BE REMOVED WHEN THEY HAVE SERVED THEIR USEFULNESS SO AS NOT TO BLOCK OR IMPEDE FLOW OR DRAINAGE.

**4 STRAWBALE SEDIMENT BARRIERS DETAIL N.T.S.**

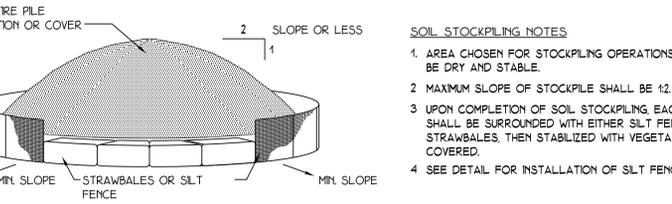


**5 SOIL STOCKPILING DETAIL N.T.S.**

**SOIL STOCKPILING NOTES**

- AREA CHOSEN FOR STOCKPILING OPERATIONS SHALL BE DRY AND STABLE.
- MAXIMUM SLOPE OF STOCKPILE SHALL BE 1:2.
- UPON COMPLETION OF SOIL STOCKPILING, EACH PILE SHALL BE SURROUNDED WITH EITHER SILT FENCING OR STRAWBALES, THEN STABILIZED WITH VEGETATION OR COVERED.
- SEE DETAIL FOR INSTALLATION OF SILT FENCE.

**1 EROSION CONTROL PLAN 1"=20'-0"**

THE INFORMATION ABOVE WAS TAKEN FROM AN OWNER PROVIDED SURVEY. ACCURACY IS LIMITED TO THE DATA PROVIDED THEREIN. ARCHITECT IS NOT RESPONSIBLE FOR INFORMATION PROVIDED BY OTHERS.

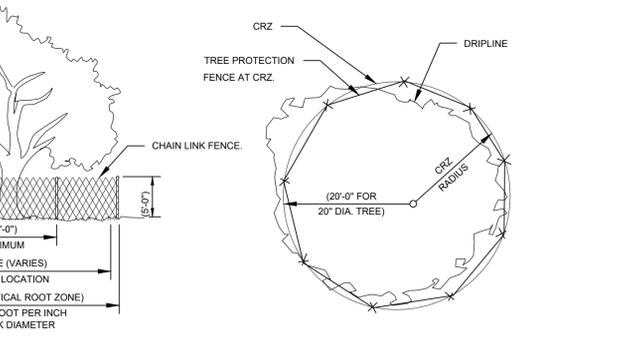

**2 TREE PROTECTION FENCE DETAIL N.T.S.**

CRZ  
TREE PROTECTION FENCE AT CRZ  
CHAIN LINK FENCE  
DRIPLINE  
(20'-0" FOR 20" DIA. TREE)  
CRZ RADIUS  
(10'-0" MAXIMUM)  
FENCE LOCATION  
(LIMITS OF CRITICAL ROOT ZONE)  
RADIUS=1 FOOT PER INCH OF TRUNK DIAMETER

EROSION CONTROL PLAN, DETAILS AND NOTES  
PROJECT INFO:  
**PROPOSED 2 STORY RESIDENCE FOR:**  
JOHN MARRICCO  
125 MORNINGSID DRIVE  
OSSISING, NEW YORK 10591

SHEET TITLE:  
PROJECT #:  
DATE:  
SCALE:  
DRAWN BY:  
SEAL:



DRAWING: