
# THE LEARNING EXPERIENCE


530 NORTH STATE ROAD, TOWN OF OSSINING, BRIARCLIFF MANOR, WESTCHESTER COUNTY, STATE OF NEW YORK SECTION 90.15, BLOCK 2, LOT 18

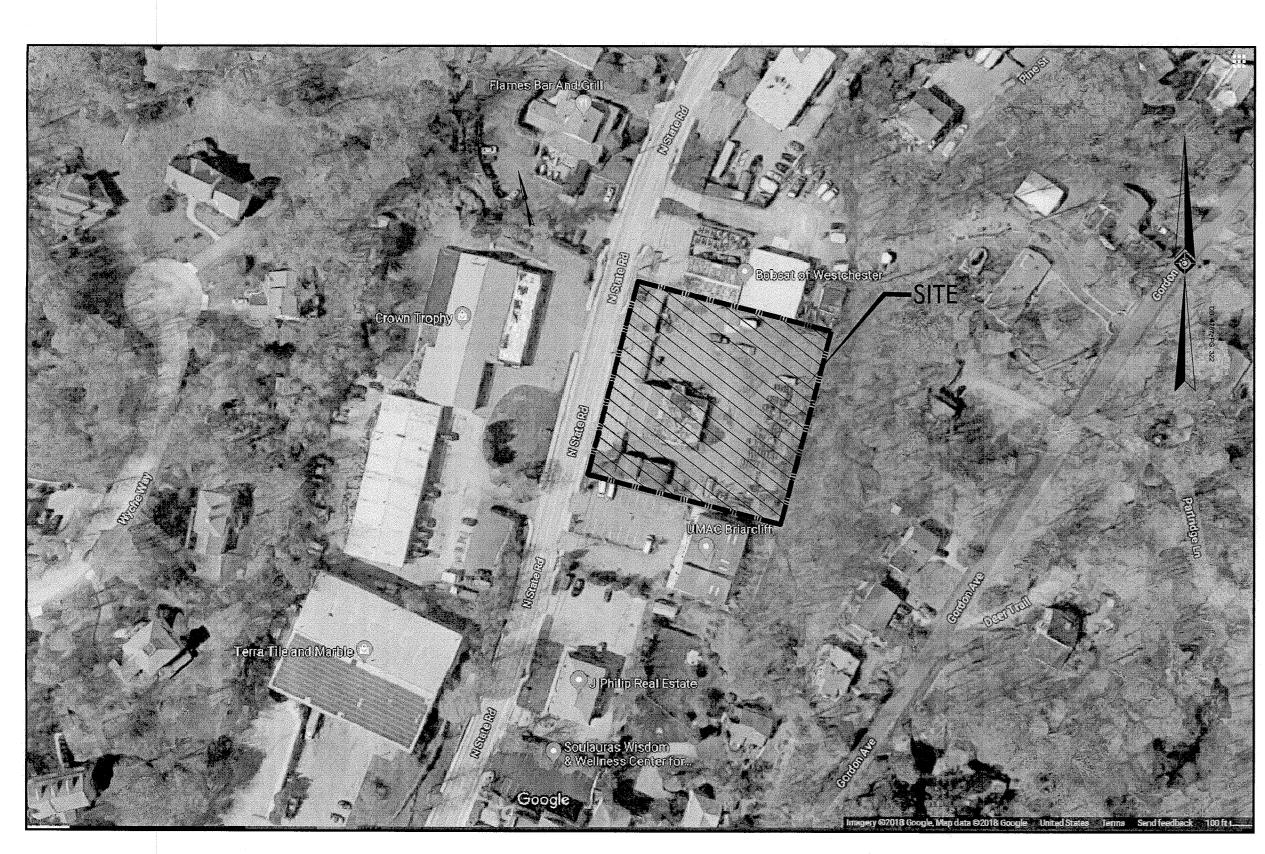

## **AERIAL MAP**

SCALE: 1"=100'

·		ZONING SO	HEDULE			-
And the second s	Z	ONE - GB - GENE	RAL BUSINESS			
Bulk Regulation		Requirement	Existing		Proposed	
	Units					
Principal Permitted Uses		See Note 2	STORAGE YARD FOR CONSTRUCTION EQUIPMENT	С	CHILDCARE FACILITY	C
Lot Area	S.F.	20,000	43,264	C	43,264	C
Lot Width	Feet	100	208	C	208	C
Lot Depth	Feet	130	208	С	208	С
Front Yard	Feet	30	29.2	C	30.0	С
Side Yard	Feet	-	54.9	С	12.2	С
Rear Yard along any Residence District Bo	undary Feet	30	110.7	С	39.7	C
Rear Yard Landscape Buffer To Residence	District Feet	20	0.0	ENC	2 (see note 3)	V
Max. Building Height	Stories	2	1	C	1	С
Max. Building Height Fee		35	< 35	C	23	С
Aggregate Floor Area on any Lot	S.F.	-	3,706	С	10,000	С
Building Coverage	%	30	8.6	С	23.1	С
Abbreviations		~				
C Conforms						
ENC Existing Non Conformance						
V Variance Required						
Notes:		· · · · · · · · · · · · · · · · · · ·				
7 Code based on Town of Ossining (We	chester, NY), Zoni	ng Ordinance, 200-23,	Amended 06-14-94.			
2 As per Township Code, Ordinance 200	0-18 A. (10) permit	tted uses are child-care o	and elder-care facilities.			
3 6' tall fence provided along rear of site						

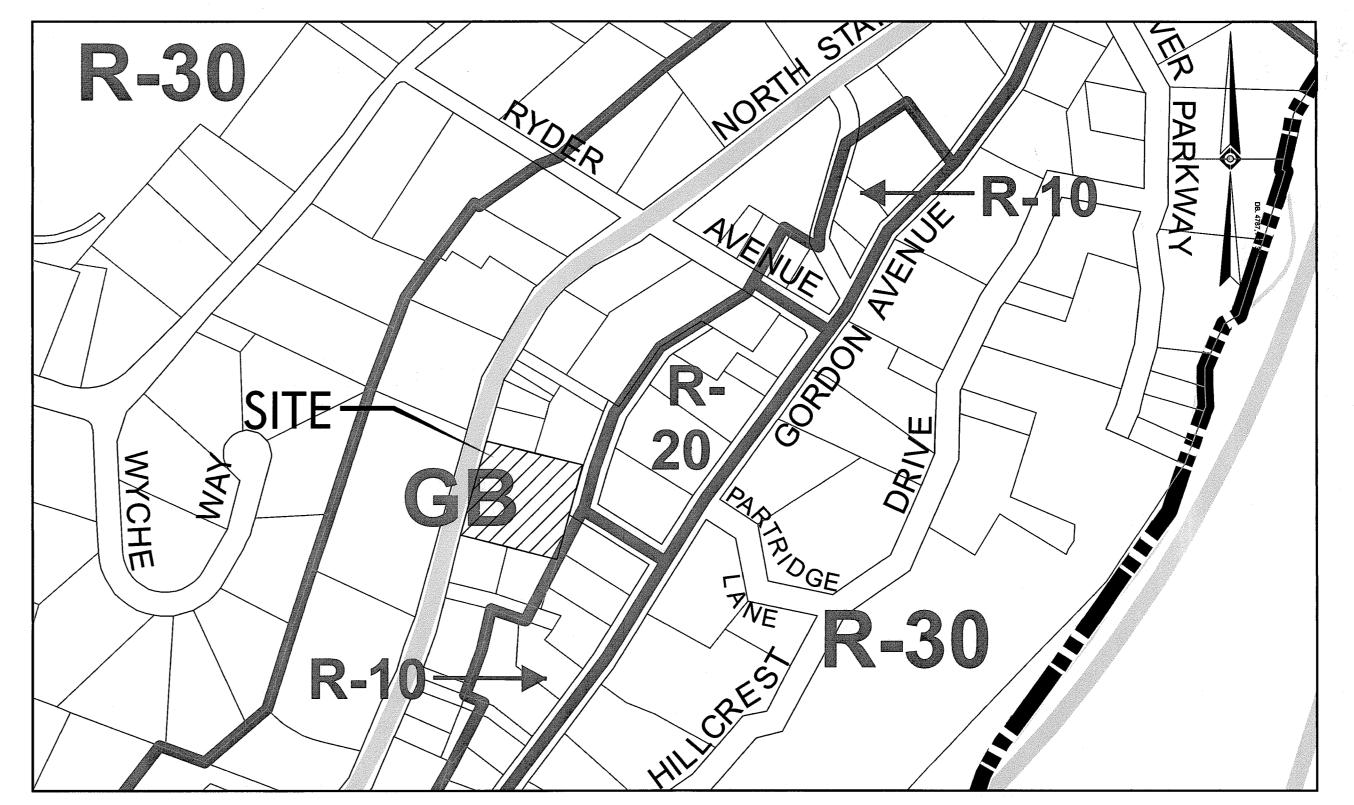

## ZONING MAP SCALE: 1"=200"

PROJECT C	ONTACTS
APPLICANT: BRIARCLIFF MANOR PARTNERS, LLC c\o JARMEL KIZEL ARCHITECTS AND ENGINEERS, INC. 42 OKNER PARKWAY LIVINGSTON, NJ 07039	ENGINEER: RICHARD A. JARMEL, PE JARMEL KIZEL ARCHITECTS AND ENGINEERS, INC. 42 OKNER PARKWAY LIVINGSTON, NJ 07039
OWNER:  NSRR REALTY, LLC  c/o BOBCAT OF NEW YORK, INC.  58-64A MAURICE AVENUE  MASPETH, NEW YORK 11378  ATTORNEY:  ADAM L. WEKSTEIN, ESQ  HOCHERMAN TORTORELLA &	ARCHITECT: MATTHEW B. JARMEL, AIA JARMEL KIZEL ARCHITECTS AND ENGINEERS, INC. 42 OKNER PARKWAY LIVINGSTON, NJ 07039

WEKSTEIN, LLP

ONE NORTH BROADWAY, SUITE 701

WHITE PLAINS, N.Y. 10601

PRELIMINARY/FINAL SITE PLAN OF: "THE LEARNING EXPERIENCE"		
SECTION 90.15, BLOCK 2, LOT 18		
I HAVE REVIEWED THIS SITE PLAN AND CERTIFY THAT IT MEETS ALL CODES AND ORDINANCES UNDER MY JURISDICTION.		
(MUNICIPAL ENGINEER)	(DATE)	
APPROVED BY THE PLANNING BOARD		
(CHAIRMAN)	(DATE)	
(SECRETARY)	(DATE)	

SHEET NO.	DRAWING NO.	DRAWING NAME	DATE	LAST REV. DATE
1	C-001	COVER SHEET	4-27-18	
2	C-100	EXISTING CONDITIONS PLAN	4-27-18	
3	C-200	DEMOLITION PLAN	4-27-18	
4	C-300	SITE AND UTILITIES PLAN	4-27-18	
5	C-400	GRADING AND DRAINAGE PLAN	4-27-18	
6	C-600	LANDSCAPING PLAN	4-27-18	
7	C-650	LIGHTING PLAN AND DETAILS	4-27-18	
8	C-700	SOIL EROSION AND SEDIMENT CONTROL PLAN	4-27-18	
9	C-900	DETAIL SHEET	4-27-18	
10	C-901	DETAIL SHEET	4-27-18	
11	C-902	DETAIL SHEET	4-27-18	

Architecture
Engineering
Interior Design
Implementation Services

TEL: 973-994-9669 FAX: 973-994-4069

NO. DATE	DESCRIPTION	INT.
1. 5.23.18	INITIAL SUBMISSION	GPG
	·	
	REVISION	
NO. DATE	DESCRIPTION	INT.

PRINCIPALS	
MATTHEW B. JARMEL, AIA, MBA	NJ LIC AI0-12787
AZ LIC 48159	MN LIC 46404
CO LIC ARC-401483	
CT LIC ARI.0011415	
DC LIC ARC101849	NY LIC 024673
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FL LIC AR94034	PA LIC RA-014851-8 RI LIC ARC.0004765
GA LIC RA011484	SC LIC AR. 9163
IA LIC 05577	
IL LIC 001.020069 MA LIC AR10286	TN LIC 103850 TX LIC 20992
MD LIC 12662 MI LIC 1301052189	VA LIC 0401 014089
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CT LIC PEN0027735 FL LIC 70134	NY LIC 073898-1
MI LIC 0201032333	PA LIC PE070600
DE LIC 18754	MA LIC 50445
ASSOCIATES VT LIC 88498	TX LIC 123822
RONALD A, BROKENSHIRE, PE	NJ LIC GE45511
CT LIC PEN.0032811	
DAVID L. LESESNE, RA	NJ LIC AI 13231
CT LIC ARI-0011748	NY LIC 024719
MA LIC 31425	PA LIC RA-405081 NY LIC 036993
MICHAEL J. VORLAND, RA	NJ LIC GE038255
GERARD P. GESARIO, PE FREDERICK KINCAID, RA	NJ LIC GE038255 NJ LIC 21A1018294
JEROME LESLIE EBEN, FAIA, PP	NJ LIC AI 8883
PA LIC 016502-8	NY LIC 019151
CHERYL SCHWEIKER, AIA	NJ LIC 21Al0206906
	PA LIC RA407927
NJ State Board Of Archite NJ State Board Of Engineers & Lond Sc	cts Authorization No. 161 urveyors Authorization No. GA-2
Project: THE LEARNIN	G EXPERIENCE
	STATE ROAD
	OSSINING
BRIARCLIFF	MANOR, NY
<b>SECTION 90.15</b>	BLOCK 2, LOT 18
Project No:	Scale:
TLENY-S-17-155	AS NO
I LEIA 1-3-17-133	
Drawn By:	Approved By:

COVER SHEET

Drawing Number:


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of:

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Jarmel Kizel

ARCHITECTS AND ENGINEERS INC.

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INC. TON MENW JERSEY 07020

42 OKNER PARKWAY LIVINGSTON, NEW JERSEY 07039 TEL: 973-994-9669 FAX: 973-994-4069 www.jarmelkizel.com
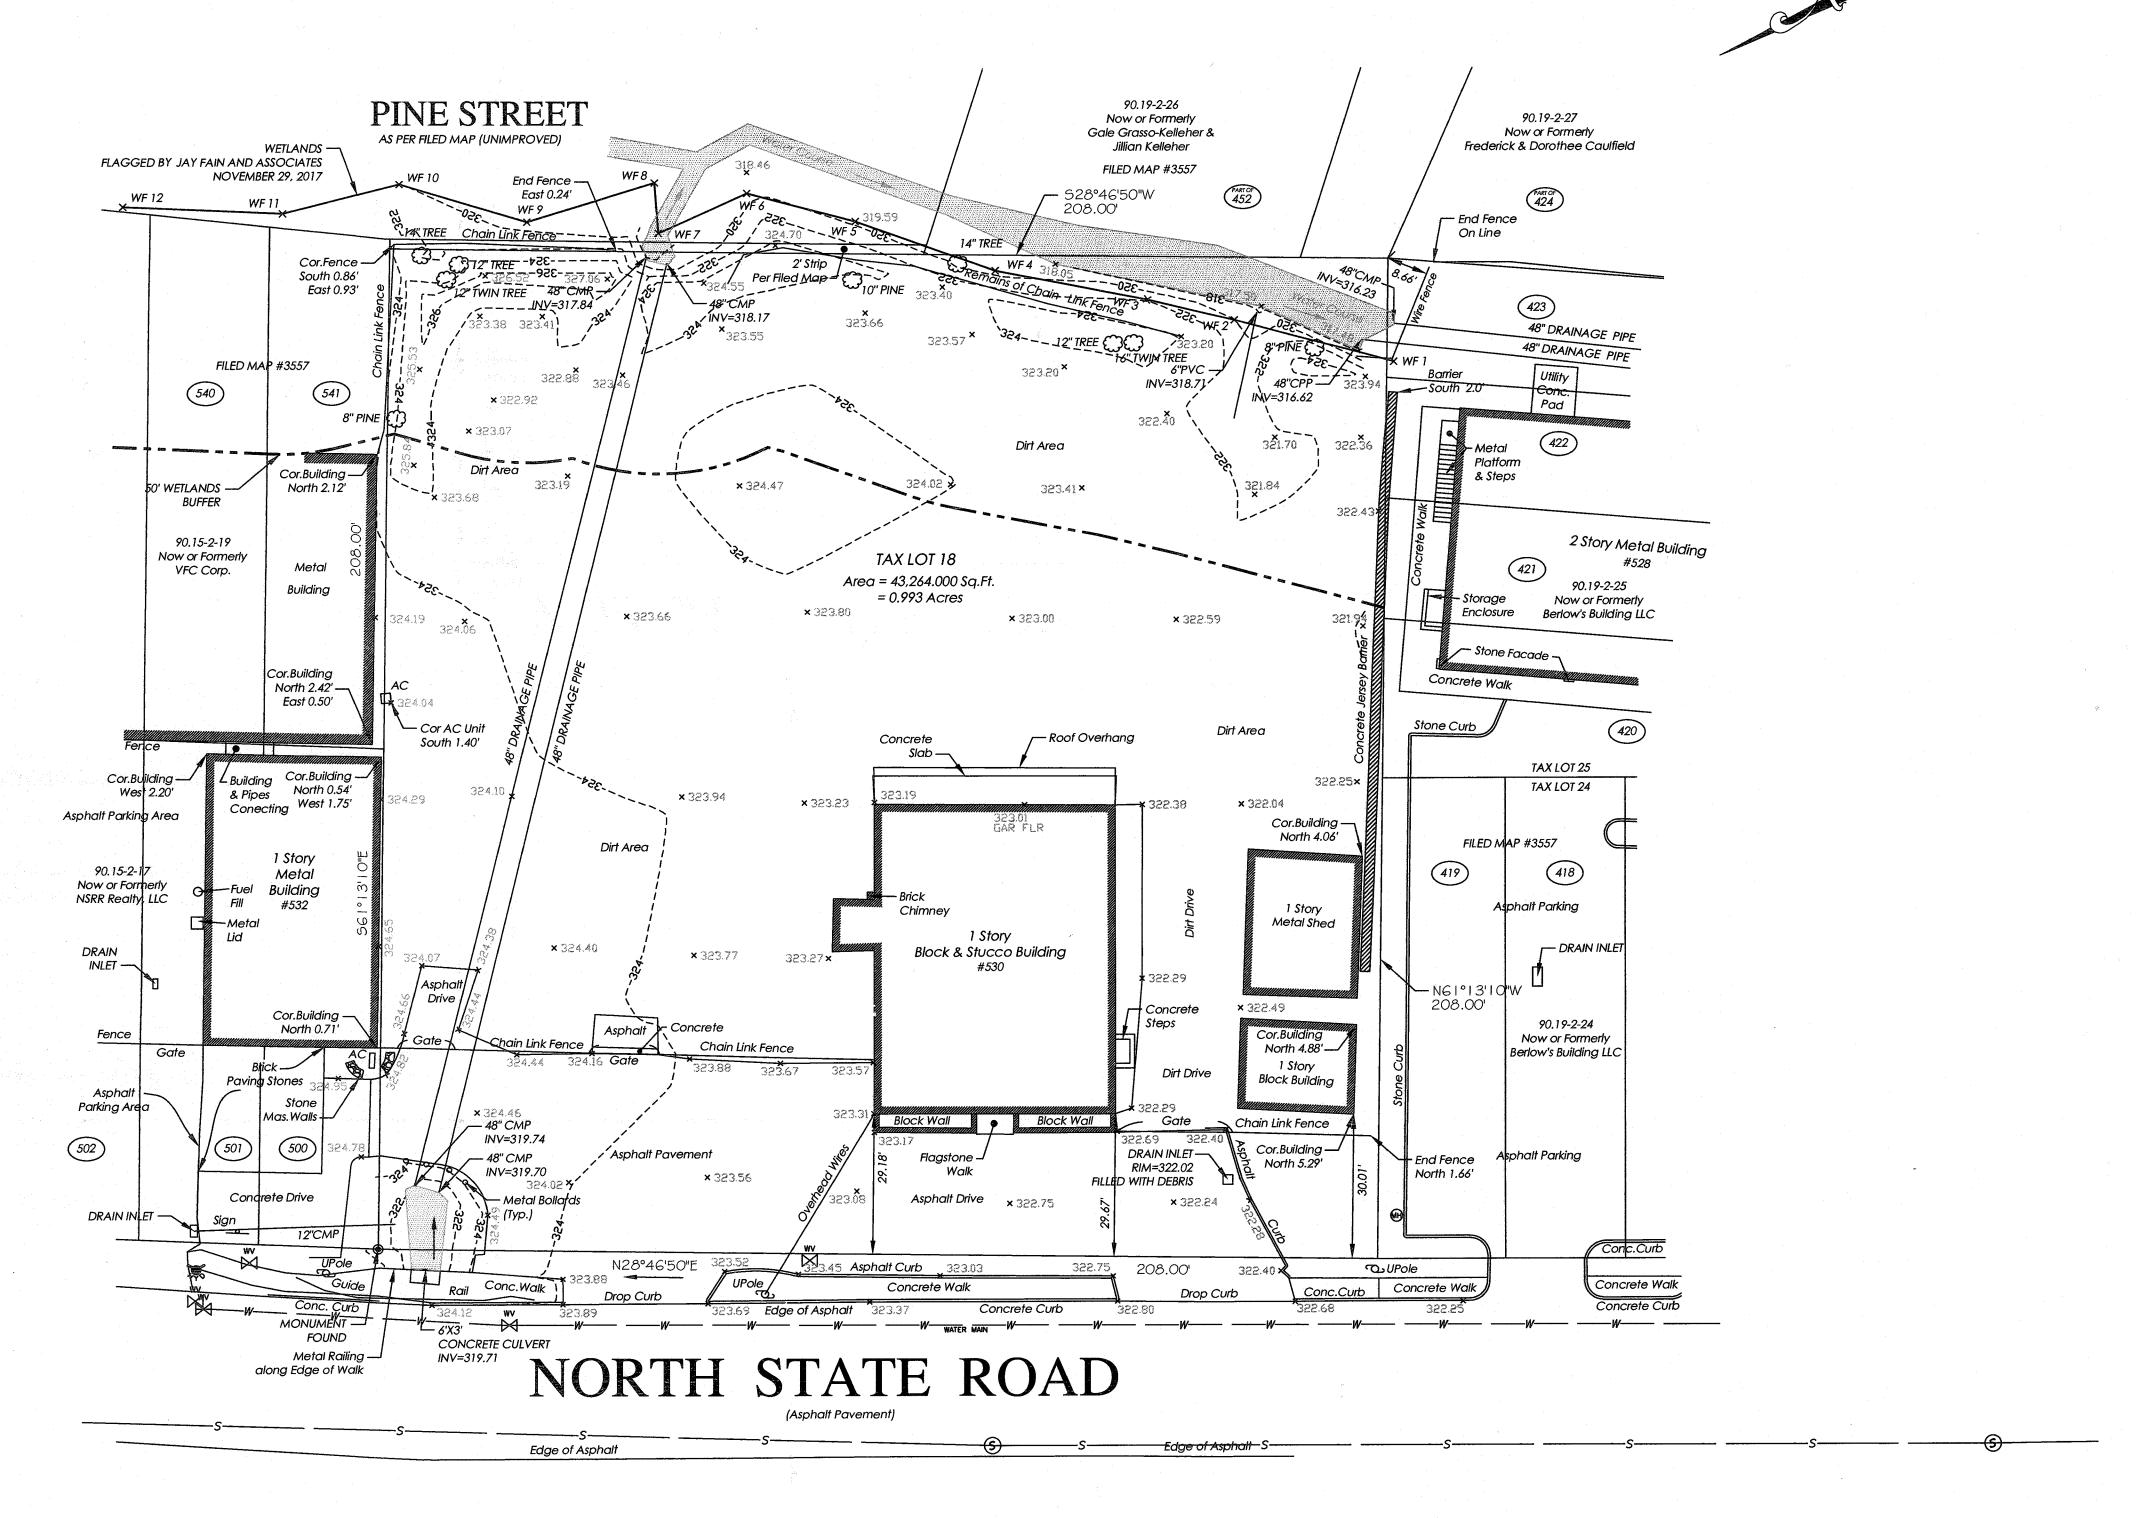
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Engineering
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		REVISIÓN	
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PRINCIPALS	
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AZ UC 48159	MN LIC 46404
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DE LIC S5-0007256	OH LIC A-99-1
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GA LIC RA011484	RI LIC ARC.00
IA LIC 05577	SC LIC AR.916
IL LIC 001.020069	TN LIC 10385
MA LIC AR10286	TX LIC 20992
MD LIC 12662	VA LIC 0401 0
MI LIC 1301052189	VT LIC 2453 NJ LIC 21AI00
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FL LIC 70134	NY LIC 07389
MI LIC 6201052339	PA LIC PE070 MA LIC 50445
DE LIC 18754 VT LIC 88498	TX LIC 12382
ASSOCIATES VI LIC 80490	1A LIC 12302
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CT LIC PEN.0032811	PA LIC PE0858
DAVID L. LESESNE, RA	NJ LIC AI 1323
CT LIC ARI-0011748 MA LIC 31425	NY LIC 02471 PA LIC RA-405
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GERARD P. GESARIO, PE	NJ LIC GE03
FREDERICK KINCAID, RA	NJ LIC 21A1
JEROME LESLIE EBEN. FAIA. PP	NJ LIC AI 888

NJ Stote 80ord Of Architects Authorization No. 161
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Project: THE LEARNING EXPERIENCE
530 NORTH STATE ROAD
TOWN OF OSSINING
BRIARCLIFF MANOR, NY
SECTION 90.15, BLOCK 2, LOT 18

	1.0100.7.107			
1	TLENY-S-17-155		1" = 20	
	Drawn By:	Approved By:		
	LB		RA	
	Drawing Name:			

**EXISTING CONDITIONS PLAN** 


C-10

Sheet No: of:

RIGHARD A JARMEL
PROFESSIONAL
BENGINEER
N.Y. LIG-#075898-1

#### **DEMOLITION NOTES:**

- 1. BOUNDARY & TOPOGRAPHY INFORMATION IS BASED ON A SURVEY TITLED "TOPOGRAPHY OF PROPERTY PREPARED FOR NSRR REALTY, LLC SITUATED IN THE TOWN OF OSSINING, WESTCHESTER COUNTY, NEW YORK" BY TC MERRITTS LAND SURVEYORS, 394 BEDFORD ROAD, PLEASANTVILLE, NY 10570 WITH LATEST REVISION DATE 12/4/2017.
- CONTRACTOR SHALL VISIT THE SITE TO VERIFY EXISTING CONDITIONS AND SHALL VERIFY ALL DIMENSIONS IN FIELD PRIOR TO CONSTRUCTION AND NOTIFY ENGINEER OF ANY DISCREPANCY ON DRAWINGS.
- THE CONTRACTOR IS RESPONSIBLE FOR THE DEMOLITION, REMOVAL AND DISPOSING IN A LEGAL MANNER IN A LOCATION APPROVED BY ALL GOVERNING AUTHORITIES, OF ALL CONCRETE PADS, ASPHALT PARKING, CURBS, ETC, SUCH THAT ALL THE IMPROVEMENTS SHOWN ON THE REMAINING PLANS CAN BE CONSTRUCTED.
- 4. CONTRACTOR SHALL BE RESPONSIBLE FOR NECESSARY DISCONNECTS OF THE EXISTING UTILITY AND RECONNECTION SHALL BE
- 5. IT IS CONTRACTOR'S RESPONSIBILITY TO NOTIFY ALL UTILITY COMPANIES AS REQUIRED PRIOR TO DEMOLITION.
- 6. CONTRACTOR IS DESIGNATED TO MAKE REMOVALS AND DISPOSAL OF THE MATERIALS IS HIS RESPONSIBILITY.
- 7. CONTRACTOR SHALL KEEP THE JOB FREE OF DEBRIS AND MAKE FINAL CLEAN UP TO THE SATISFACTION OF THE OWNER.
- 8. CONTRACTOR SHALL CARRY OUT THE WORK OF THIS CONTRACT PLACING THE SAFETY AND PROTECTION OF THE SURROUNDING COMMUNITY AND PROPERTY AT THE HIGHEST PRIORITY.
- 9. THE CONTRACTOR SHALL IMPLEMENT ALL NECESSARY MEASURES TO PROTECT ADJACENT AND ON-SITE PROPERTY, STRUCTURES AND UTILITIES THAT ARE TO REMAIN INTACT WHILE PERFORMING THE SPECIFIED WORK.
- 10. THE CONTRACTOR SHALL ENSURE FREE AND SAFE PASSAGE OF PERSONS AROUND THE AREA OF THE DEMOLITION AS DIRECTED BY THE OWNER AND THE MUNICIPAL OFFICIALS. THE OWNER'S REPRESENTATIVE IS NOT RESPONSIBLE FOR JOBSITE SAFETY.
- 11. ALL SIDEWALK, CURBS, DRIVEWAYS, PIPES, STRUCTURES TO REMAIN SHALL BE PROTECTED FROM DAMAGE BY THE CONTRACTOR. ANY DAMAGE DURING CONSTRUCTION SHALL BE RESTORED, RECONSTRUCTED OR REPLACED BY THE CONTRACTOR AT HIS
- 12. CONTRACTOR SHALL BE RESPONSIBLE TO PROVIDE TRAFFIC CONTROL DEVICES REQUIRED BY THE MUNICIPALITY AND LOCAL
- 13. PULVERIZED CONCRETE OR MASONRY SHALL NOT BE USED AS BACKFILL MATERIAL.
- 14. IF ANY HAZARDOUS MATERIALS ARE ENCOUNTERED THE OWNER/ENGINEER SHALL BE NOTIFIED IMMEDIATELY.
- 15. CONTRACTOR SHALL BE RESPONSIBLE EACH DAY TO INSPECT AND REMOVE ALL DIRT, GRAVEL AND LOOSE MATERIAL DUMPED, SPILLED, ETC FROM THE CONSTRUCTION SITE ONTO OTHER SITES, ROW, PUBLIC OR PRIVATE STREET.
- 16. CONTRACTOR SHALL REDUCE THE AIRBORNE DUST DURING THE DEMOLITION AND MAINTAIN EROSION CONTROL DEVICES AS REQUIRED.
- 17. THE CONTRACTOR IS RESPONSIBLE FOR REMOVING ALL DEBRIS FROM THE SITE AND DISPOSING THE DEBRIS IN A LAWFUL MANNER. THE CONTRACTOR IS RESPONSIBLE FOR OBTAINING ALL PERMITS REQUIRED FOR DEMOLITION AND DISPOSAL. PRIOR TO DEMOLITION OCCURRING, ALL EROSION CONTROL DEVICES ARE TO BE INSTALLED.
- 18. SHOULD REMOVAL AND/OR RELOCATION ACTIVITIES DAMAGE FENCING, CURBING, PAVEMENT, LIGHTING AND/OR STORM INLETS STRUCTURES, THEN THE CONTRACTOR SHALL PROVIDE NEW MATERIALS/STRUCTURES IN ACCORDANCE WITH THE CONTRACT DOCUMENTS. ALL CONSTRUCTION MATERIALS SHALL BE NEW.
- 19. CONTRACTOR MAY LIMIT SAW-CUT & PAVEMENT REMOVAL TO ONLY THOSE AREAS WHERE IT IS REQUIRED AS SHOWN ON THESE CONSTRUCTION PLANS BUT IF ANY DAMAGE IS INCURRED ON ANY OF THE SURROUNDING PAVEMENT, CURBING, ETC., THE CONTRACTOR SHALL BE RESPONSIBLE FOR ITS REMOVAL AND REPAIR.
- 20. CONTRACTOR SHALL REPLACE ALL CURBING ALONG THE SITE FRONTAGE THAT HE DAMAGES (AS DIRECTED BY THE TOWNSHIP OR COUNTY, AS APPLICABLE).

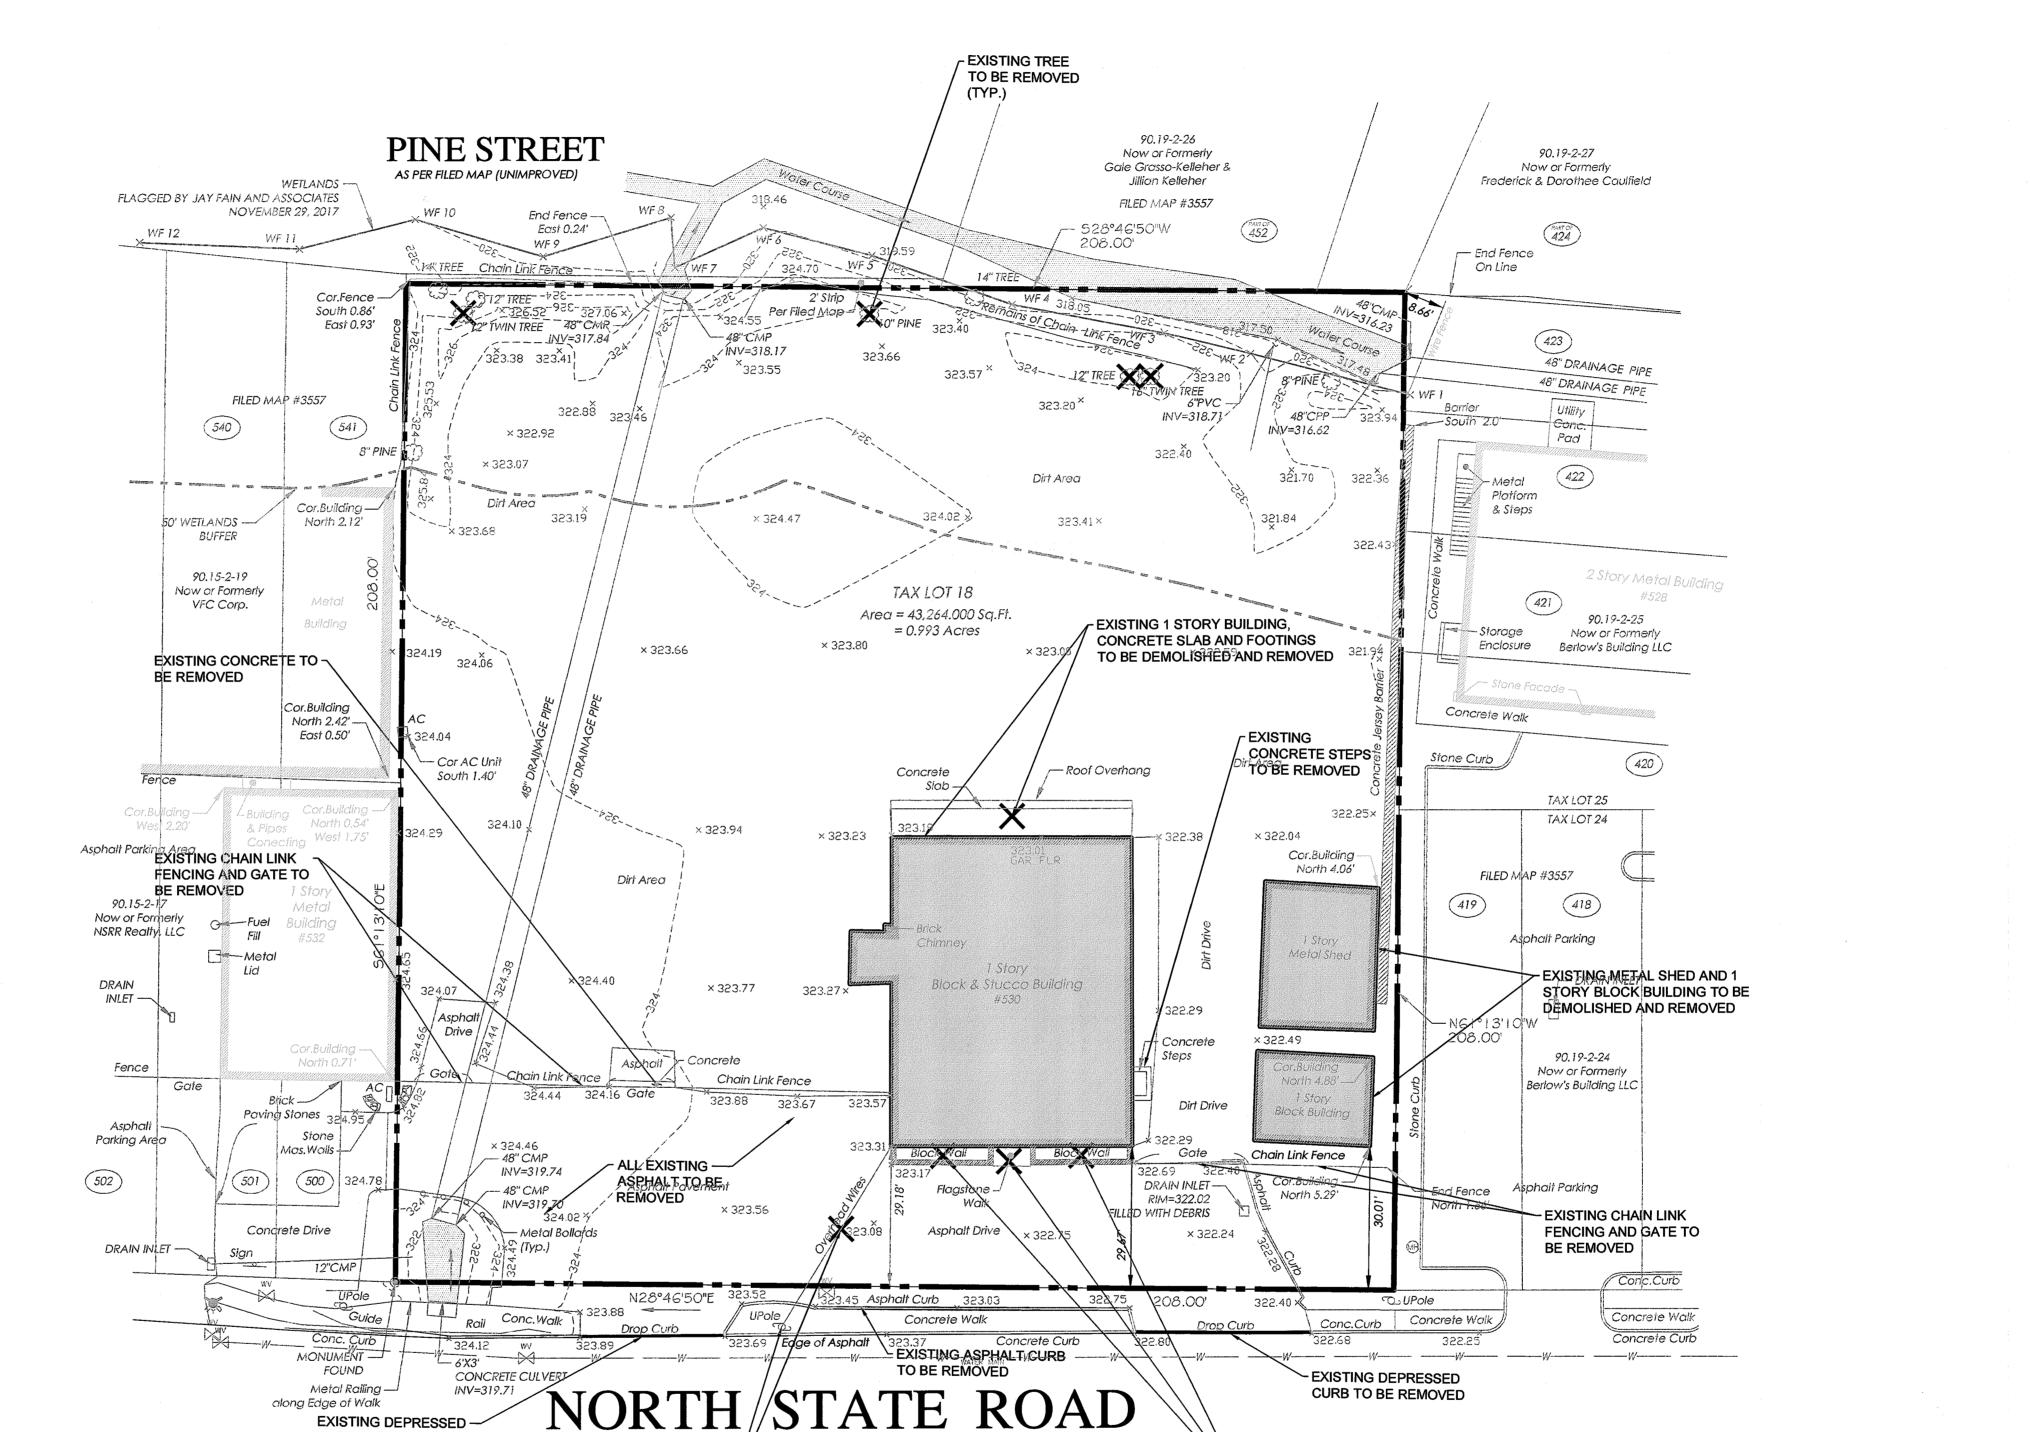

(Asphalt Pavement)

CURB TO BE MODIFIED.

Edge of Asphalt

EXISTING POLE AND OVERHEAD -

RELOCATED BY UTILITY COMPANY.

DETERMINED BY UTILITY COMPANY.

WIRES TO BE REMOVED AND

NEW LOCATIONS TO BE

SEE SITE PLAN

- EXISTING CURB & ASPHALT TO BE REMOVED FOR SEWER CONNECTION

Edge of Aphalt S

EXISTING BLOCK WALLS AND

FLAGSTONE WALK TO BE

DEMOLISHED AND REMOVED



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Implementation Services

TEL: 973-994-9669

FAX: 973-994-4069

		ISSUE	
NO.	DATE	DESCRIPTION	INT.
1.	5.23.18	INITIAL SUBMISSION	GPC
		***************************************	
		revision	
NO.	DATE	DESCRIPTION	INT.

INEW D. JAK	REL, AIA, MDA	147	LIC AID-12/6/
AZ	LIC 48159		LIC 46404
co	LIC ARC-401483		LIC 10120
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IL.		TN	LIC 103850 LIC 20992
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MD	LIC 12662 LIC 1301052189	VA VT	LIC 0401 014089 LIC 2453
IN H. KIŽE	LIC 1301032169	LN	LIC 21Al0079470
	LIC 08522	LN LN	PP LIC 33U00243
IARD A. JA		LN LN	LIC 37491
TARD A. CT	LIC PEN0027735	MN	LIC 47482
FL	LIC PEN0027735 LIC 70134 LIC 6201052339	NY	LIC 47482 LIC 073898-1 LIC PE070600
MI DE	LIC 6201052339 LIC 18754	PA	LIC PE0/0600 LIC 50445
VT	LIC 18754 LIC 88498	TX	LIC 123822
OCIATES "	LIC 00470	"	LIC 123022
ALD A. BROK	ENSHIRE, PE	LИ	LIC GE45511
	IC PEN.0032811	PA	LIC PE085817
ID L. LESESNE	, RA		LIC AI 13231
	LIC ARI-0011748		LIC 024719
	LIC 31425		LIC RA-405081
IAEL J. VORL	•		LIC 036993
ARD P. GESAR		NJ	
ERICK KINCA		NJ	
	EN, FAIA, PP	NJ	LIC AI 8883 LIC 019151
	IC 016502-8		LIC 21AI020690
RYL SCHWEIK	EK, AIA	PA	
		17	LIC 10-40/72/

NJ LIC AI0-12787

NJ State 8oard Of Architects Authorization No. 161 NJ State Board Of Engineers & Land Surveyors Authorization No. GA-27817 THE LEARNING EXPERIENCE 530 NORTH STATE ROAD TOWN OF OSSINING **BRIARCLIFF MANOR, NY** SECTION 90.15, BLOCK 2, LOT 18

TLENY-\$-17-155 Approved By:

**DEMOLITION PLAN** 


- 2. REFER TO ARCHITECTURAL DRAWINGS FOR EXACT DOOR LOCATIONS.
- 3. ALL CONSTRUCTION IS TO BE PERFORMED IN CONFORMANCE WITH ALL APPLICABLE LOCAL, COUNTY, STATE, AND FEDERAL CODES.
- 4. CONSTRUCTION MATERIALS AND METHODS NOT OTHERWISE SPECIFIED OR SHOWN HEREIN SHALL CONFORM TO NJDOT STANDARD SPECIFICATIONS FOR ROAD AND BRIDGE CONSTRUCTION (LATEST EDITION AND AMENDMENTS).
- THESE PLANS DEPICT THE SITE WORK IMPROVEMENTS FOR THIS PROJECT. THE CONTRACTOR SHALL FURNISH, INSTALL, TEST AND COMPLETE ALL WORK TO THE SATISFACTION OF THE ENGINEER AND OWNER IN ACCORDANCE WITH THE CONTRACT DOCUMENTS. THE CONTRACTOR SHALL BE SOLELY RESPONSIBLE FOR MEANS AND METHODS, TECHNIQUES, SEQUENCE OF CONSTRUCTION AND JOB SITE SAFETY. AS SUCH, THESE PLANS ARE NOT INTENDED TO REPRESENT SPECIFIC INSTRUCTIONS REQUIRED FOR SITE WORK CONSTRUCTION. THE CONTRACTOR SHALL BE RESPONSIBLE TO CONSTRUCT ALL IMPROVEMENTS DEPICTED ON THESE PLANS IN ACCORDANCE WITH ALL APPLICABLE RULES, REGULATIONS AND LAWS IN EFFECT AT THE TIME OF CONSTRUCTION.
- 6. THE CONTRACTOR SHALL ACCEPT THE SITE AS IS. THE CONTRACTOR SHALL ASSESS CONDITIONS, AND THE KIND, QUALITY AND QUANTITY OF WORK REQUIRED. THE OWNER MAKES NO GUARANTEE IN REGARD TO THE ACCURACY OF ANY AVAILABLE INFORMATION WHICH WAS OBTAINED DURING INVESTIGATIONS. THE CONTRACTOR SHALL MAKE A THOROUGH INSPECTION OF THE SITE IN ORDER TO REVEAL EXISTING CONDITIONS, CORRELATE CONDITIONS WITH THE DRAWINGS AND RESOLVE ANY POSSIBLE CONSTRUCTION CONFLICTS WITH THE OWNER AND ENGINEER PRIOR TO BIDDING, ORDERING MATERIALS, AND COMMENCEMENT OF WORK. THE CONTRACTOR SHALL MAKE ADDITIONAL TOPOGRAPHIC SURVEYS HE DEEMS NECESSARY, PROVIDED THEY ARE COORDINATED WITH THE OWNER. ANY CONDITIONS DETERMINED BY THE CONTRACTOR THAT DIFFER FROM THE INFORMATION SHOWN ON THE DRAWINGS THAT ARE NOT BROUGHT TO THE ATTENTION OF THE OWNER AND ENGINEER PRIOR TO THE START OF WORK SHALL NOT BE CONSIDERED GROUNDS FOR ADDITIONAL PAYMENT OR CHANGES TO THE CONTRACT DURATION, OR ANY OTHER CLAIMS AGAINST THE OWNER OR OWNER'S ENGINEER.
- 7. THE CONTRACTOR SHALL PROVIDE WRITTEN REQUESTS FOR INFORMATION (RFIS) TO THE OWNER AND ENGINEER PRIOR TO THE CONSTRUCTION OF ANY SPECIFIC SITE WORK ITEM. THE (RFI) SHALL BE IN A FORM ACCEPTABLE TO OWNER AND ENGINEER AND SHALL ALLOW FOR A MINIMUM OF TWO WORK DAYS OR ADDITIONAL REASONABLE TIME FOR A WRITTEN REPLY. RFIS SHALL BE NUMBERED CONSECUTIVELY BY DATE SUBMITTED. THE CONTRACTOR SHALL BE SOLELY RESPONSIBLE FOR SITE WORK ITEMS CONSTRUCTED DIFFERENTLY THAN INTENDED OR AS DEPICTED ON THE PLANS.
- 8. THE CONTRACTOR IS RESPONSIBLE TO CONTACT NEW YORK ONE CALL NOT LESS THAN 3 BUSINESS DAYS AND NOT MORE THAN 10 BUSINESS DAYS PRIOR TO THE BEGINNING OF ANY EXCAVATION OR DEMOLITION. NEW YORK ONE CALL INFORMATION PHONE: 811, WEB: WWW.DIGSAFELYNEWYORK.COM
- 9. THE CONTRACTOR SHALL SUPERVISE AND DIRECT THE WORK, USING THE CONTRACTOR'S BEST SKILL AND ATTENTION. THE CONTRACTOR SHALL BE SOLELY RESPONSIBLE AND HAVE CONTROL OVER CONSTRUCTION MEANS, METHODS, TECHNIQUES, SEQUENCES AND JOB SITE SAFETY.
- 10. THE MUNICIPAL ENGINEER MUST BE NOTIFIED ONE WEEK PRIOR TO THE CONSTRUCTION OF ANY CURBING, SIDEWALKS, PAVEMENT GRADING, OR OTHER UTILITIES.
- 11. THE CONTRACTOR MUST NOTIFY THE DESIGN ENGINEER OF ANY CONDITION OF CONFLICTS THAT WILL ALTER THE INTENT OF THE DESIGN
- 12. CONTRACTOR IS REQUIRED TO REMOVE ALL UNSUITABLE MATERIALS FROM THE SITE IN ACCORDANCE WITH ALL APPLICABLE STATE AND LOCAL REGULATIONS.
- 13. ALL PROPOSED IMPROVEMENTS TO BE IN ACCORDANCE WITH CURRENT ADA AND NY BARRIER FREE CODE REQUIREMENTS.
- 14. SUBJECT TO ALL APPLICABLE RULES, REGULATIONS, ORDINANCES AND STATUTES OF THE TOWN OF OSSINING, WESTCHESTER COUNTY AND STATE OF NEW YORK AND ANY OTHER JURISDICTION.
- 15. NO DEED RESTRICTIONS OR COVENANTS EXIST ON SITE NOR ARE ANY PROPOSED.
- 16. CONTRACTOR SHALL REPLACE ALL CURBING ALONG THE SITE FRONTAGE THAT HE DAMAGES (AS DIRECTED BY THE TOWNSHIP OR COUNTY, AS APPLICABLE).
- 17. ALL WORK WITHIN THE TOWNSHIP ROAD RIGHT OF WAY SHALL BE ACCORDING TO TOWN OF OSSINING STANDARDS.

LEGEND			
	EXISTING	PROPOSED	
PROPERTY LINE			
BUILDING LINE			
BUILDING CANOPY			
CURB LINE			
DEPRESSED CURB	N/A		
CONCRETE WALK	N/A	. 4 . 4 . 4	
SIGN	<b>w</b> and kanaya		
FENCE		xx	

	SI	GN LEGE	ND AND DETAILS
SYMBOL	QUAN.	USDOT FHA DESIGNATION	SIGN DETAIL
\$	1	R1-1	STOP 7
**	2	R7-8	PESSENED & ©
�	2	R7-8p	1—12"——————————————————————————————————
<b>(3)</b>	2	R7-8B	12"  
δχ <b>δ</b>	1	R5-1 (30x30)	DO NOT ENTER

### SIGN NOTES

- ALL SIGNS SHALL CONFORM TO THE MANUAL ON TRAFFIC CONTROL DEVICES.
- 2. SIGNS, SIGN POSTS AND THEIR FOUNDATIONS AND SIGN MOUNTING SHALL BE SO CONSTRUCTED AS TO HOLD SIGNS IN A PROPER AND PERMANENT POSITION, TO RESIST SWAYING IN THE WIND OR DISPLACEMENT BY VANDALISM.
- REFER TO MOUNTING DETAILS FOR HEIGHTS. ALL SIGNS SHALL BE MEASURED FROM PAVEMENT OR GROUND TO BOTTOM OF SIGN.

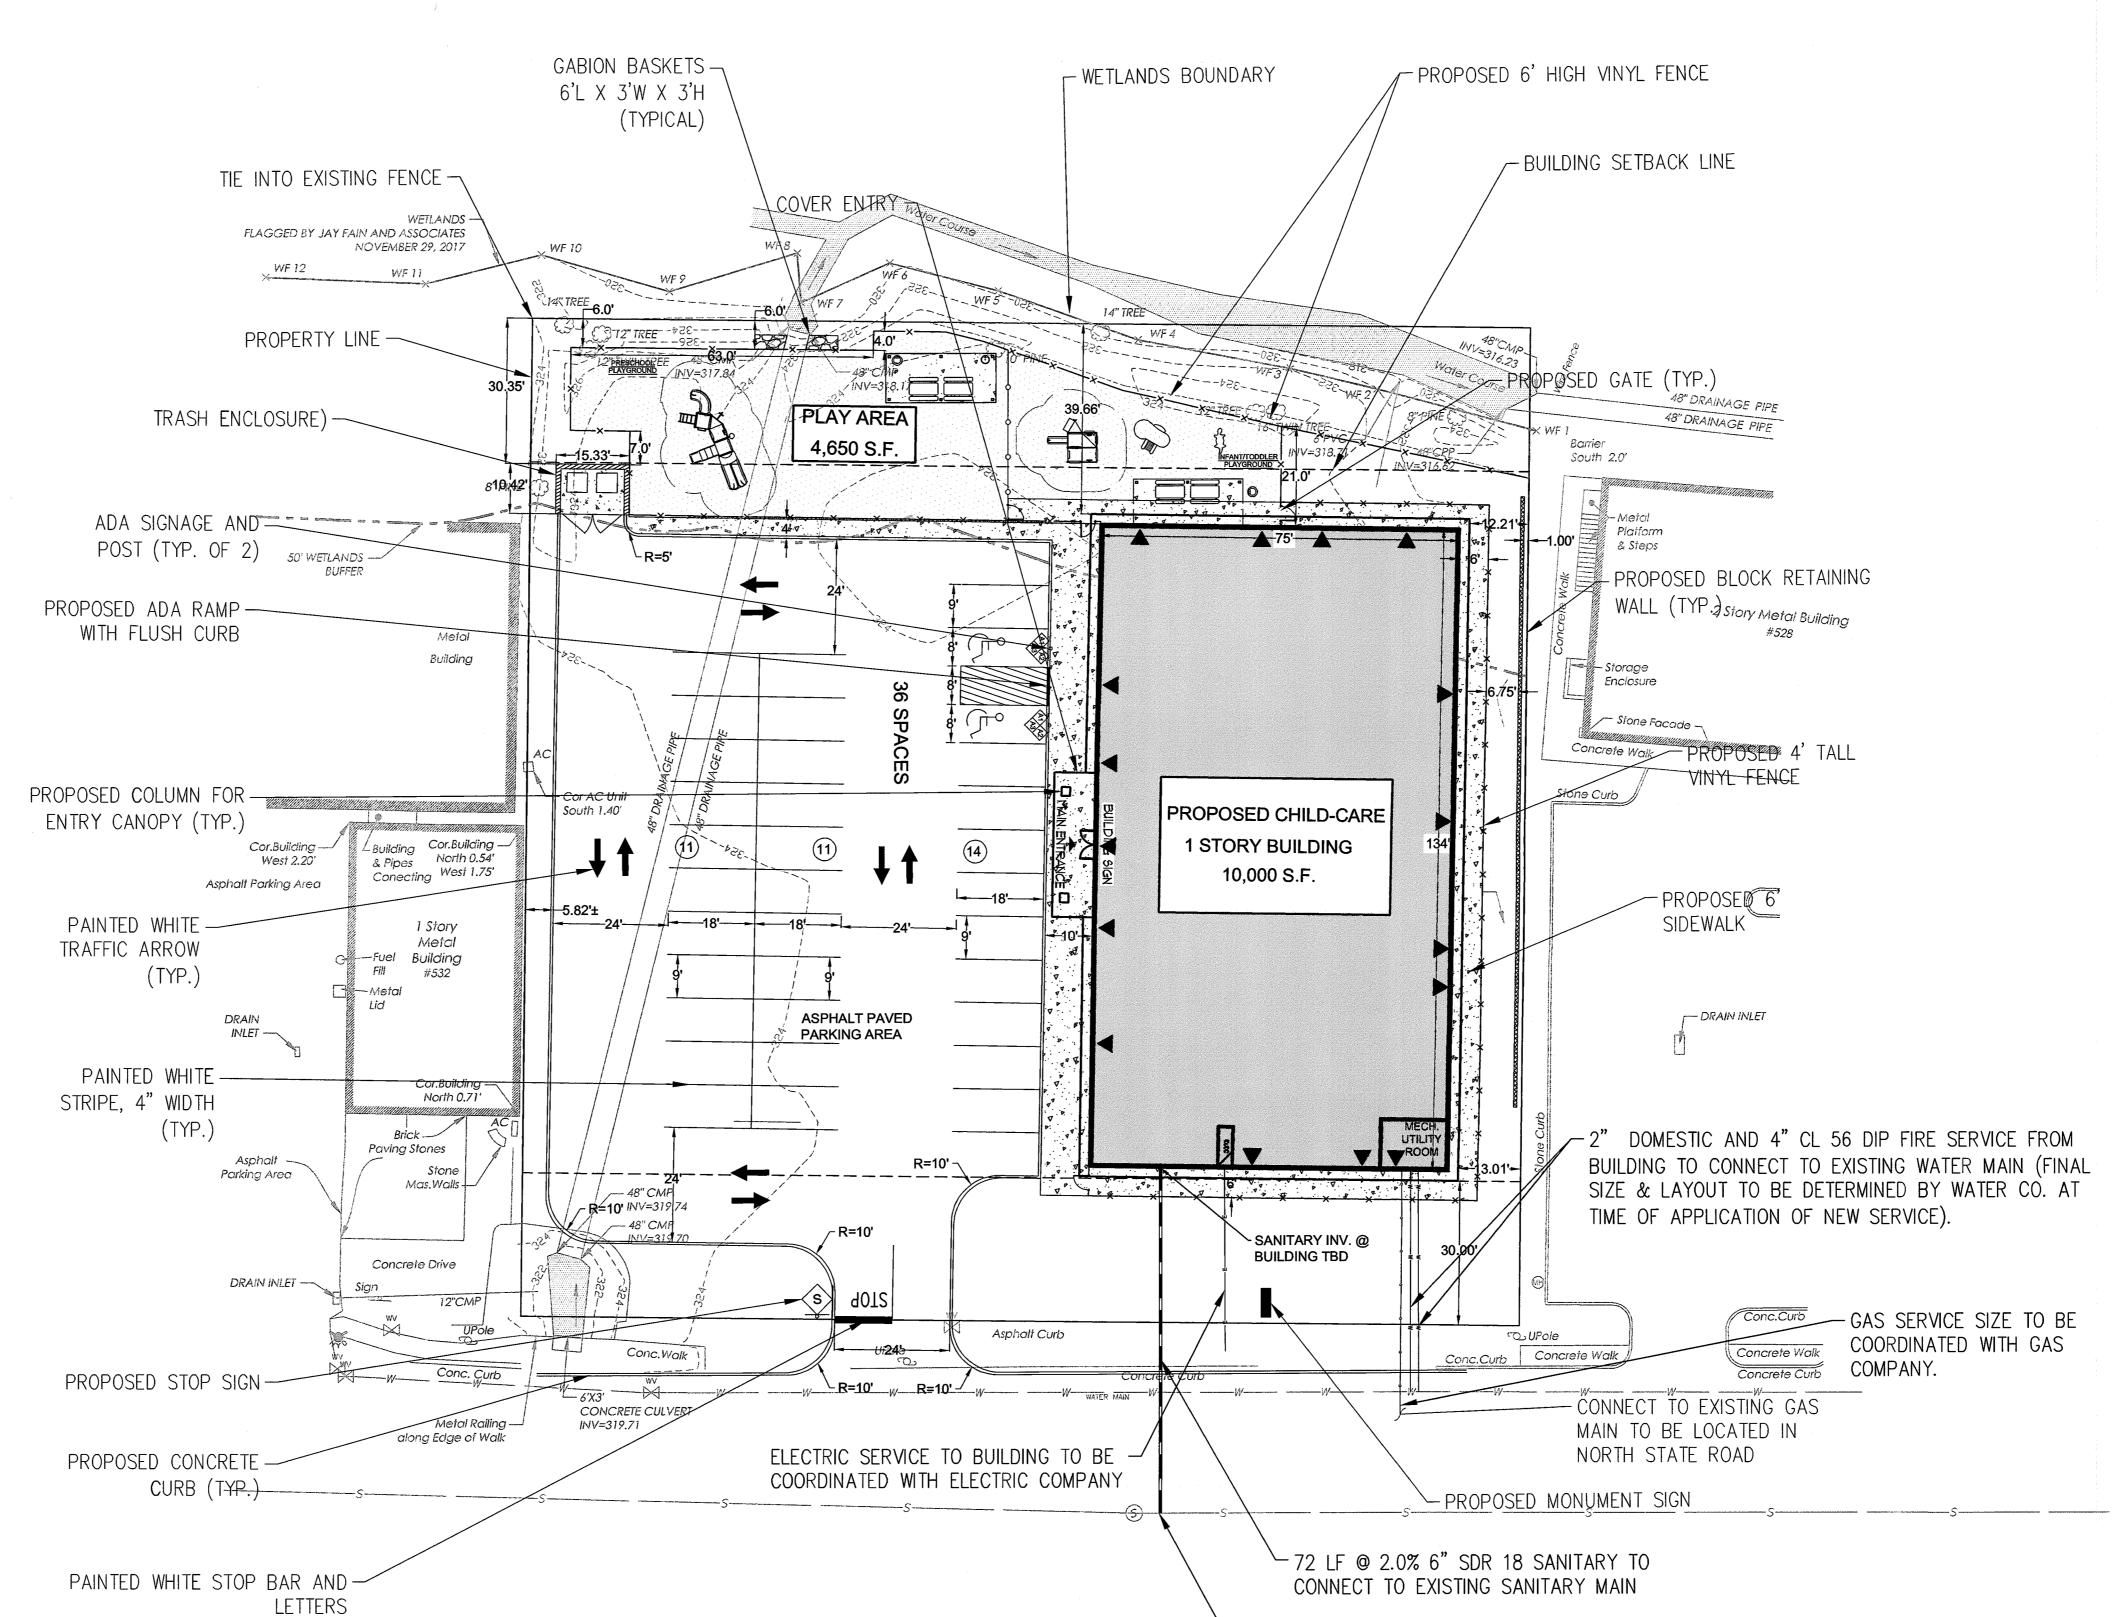

└NV. @ EXISTING SANITARY TBD



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MI LIC 301052389 PA LIC RA-014851-B

ASSOCIATES

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Project: THE LEARNING EXPERIENCE
530 NORTH STATE ROAD
TOWN OF OSSINING
BRIARCLIFF MANOR, NY

Scale:

TLENY-S-17-155

TENY-S-17-155

Approved By:

LB

RAJ

SECTION 90.15, BLOCK 2, LOT 18

SITE AND UTILITIES PLAN

rawing Number:

C-300
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4 11

FREDERICK KINCAID, RA JEROME LESLIE EBEN, FAIA, PP


11 SICHARD LIARMEN PROFESSIONAL PROFESSIONAL

- CONTRACTOR SHALL REFER TO ARCHITECTURAL PLANS AND SPECIFICATIONS FOR ACTUAL LOCATIONS OF ALL UTILITY ENTRANCES TO INCLUDE SANITARY SEWER LATERALS, DOMESTIC AND FIRE PROTECTION WATER SERVICE, ELECTRICAL TELEPHONE AND GAS SERVICE. CONTRACTOR SHALL COORDINATE INSTALLATION OF UTILITIES IN SUCH A MANNER AS TO AVOID CONFLICTS AND TO ENSURE PROPER DEPTHS ARE ACHIEVED AS WELL AS COORDINATING WITH THE UTILITY COMPANIES AS TO LOCATION AND SCHEDULING OF CONNECTIONS TO THEIR FACILITIES.
- 4. EXCAVATED MATERIAL CONTAINING ROCK OR STONE GREATER THAN SIX (6) INCHES IN LARGEST DIMENSION IS UNACCEPTABLE AS FILL TO WITHIN THE PROPOSED BUILDING AND PAVING AREA.
- 5. ROCK OR STONE LESS THAN SIX (6) INCHES IN LARGEST DIMENSION IS ACCEPTABLE AS FILL TO WITHIN TWENTY-FOUR (24) INCHES OF SURFACE OF PROPOSED SURGED WHEN MIXED WITH SUITABLE MATERIAL AS PERMITTED BY THE OWNER'S GEOTECHNICAL ENGINEER.
- ROCK OR STONE LESS THAN TWO (2) INCHES IN LARGEST DIMENSION AND MIXED WITH SUITABLE MATERIAL IS ACCEPTABLE AS FILL WITHIN THE UPPER TWENTY-FOUR (24) INCH OF PROPOSED SUBGRADE AS PERMITTED BY THE OWNER'S GEOTECHNICAL ENGINEER.
- 7. ALL SITEWORK AND EARTHWORK OPERATIONS CONDUCTED ON THE SITE TO BE PERFORMED IN ACCORDANCE WITH THE GEOTECHNICAL ENGINEERING REPORT PREPARED BY THE OWNER'S GEOTECHNICAL ENGINEER.
- 8. COMPACTION CRITERIA FOR FILL PLACED IN THE FOLLOWING AREAS SHALL MEET OR EXCEED THE FOLLOWING MINIMUM PERCENTAGE OF MAXIMUM MODIFIED PROCTOR DRY DENSITY AS DETERMINED BY ASTM D-1557 USED ON REPRESENTATIVE SOIL SAMPLES, UNLESS MORE STRINGENT CRITERIA GIVEN ELSEWHERE:

FILL_AREA	STANDARD PROCTOR DRY DENSITY
SIDEWALKS	95%
PAVEMENTS AND ROADWAYS	95%
LANDSCAPE AREAS	93%
TRENCH BACKFILL	SAME AS SURROUNDING AREA

- 9. PROTECT SUBGRADE FROM EXCESSIVE WHEEL LOADING DURING CONSTRUCTION, INCLUDING TRUCKS AND DUMP TRUCKS.
- 10. REMOVE AREAS OF FINISHED SUBGRADE FOUND TO HAVE INSUFFICIENT COMPACTION DENSITY TO DEPTH NECESSARY AND REPLACE IN A MANNER THAT WILL COMPLY WITH COMPACTION REQUIREMENTS BY USE OF MATERIAL EQUAL TO OR BETTER THAN BEST SUBGRADE MATERIAL ON SITE. SURFACE OF SUBGRADE AFTER COMPACTION SHALL BE HARD UNIFORM, SMOOTH, STABLE, AND TRUE TO GRADE AND CROSS-SECTION.
- 11. GRADE ALL AREAS WHERE FINISH GRADE ELEVATIONS OR CONTOURS ARE INDICATED ON DRAWINGS, OTHER THAN PAVED AREAS AND BUILDINGS, INCLUDING EXCAVATED AREAS, FILLED AND TRANSITION AREAS, AND LANDSCAPED AREAS. GRADED AREAS SHALL BE UNIFORM AND SMOOTH, FREE FROM ROCK, DEBRIS, OR IRREGULAR SURFACE CHANGES. FINISHED SUBGRADE SURFACE SHALL NOT BE MORE THAN 0.10 FEET ABOVE OR BELOW ESTABLISHED FINISHED SUBGRADE ELEVATION, AND ALL GROUND SURFACES SHALL VARY UNIFORMLY BETWEEN INDICATED ELEVATIONS, FINISH DITCHES SHALL BE GRADED TO ALLOW FOR PROPER DRAINAGE WITHOUT PONDING AND IN A MANNER THAT WILL MINIMIZE EROSION POTENTIAL.
- 12. ALL CONCRETE, UNLESS OTHERWISE NOTED OR SPECIFIED BY REGULATORY AUTHORITIES, SHALL BE 4000 PSI.
- 13. REPRESENTATIVES OF THE MUNICIPALITY SHALL HAVE THE RIGHT TO INSPECT THE DRAINAGE FACILITIES LOCATED ON THE PROPOSED LOT FROM TIME TO TIME AS DEEMED NECESSARY.
- 14. CATCH BASINS SHALL BE CLEANED OUT PERIODICALLY TO PREVENT THE BUILDUP OF SEDIMENT AND DEBRIS IN STRUCTURES.
- 15. ROOF LEADER CLEANOUTS LOCATED IN GRASSED AREAS SHALL BE PLASTIC SCREW CAPS WHILE ROOF LEADER CLEANOUTS LOCATED WITHIN CONCRETE AREAS SHALL BE FLUSH BRASS CAPS.

	LEGEND	
	EXISTING	PROPOSED
STORM SEWER	N/A	
PROPERTY LINE		
MANHOLE	N/A	•
CATCH BASIN	N/A	
SPOT ELEVATION	TC: 100, 57' BC: 100, 42'x	99.30 <sup>+</sup>
CONTOUR	where the second the second that the second the second the second that the se	99

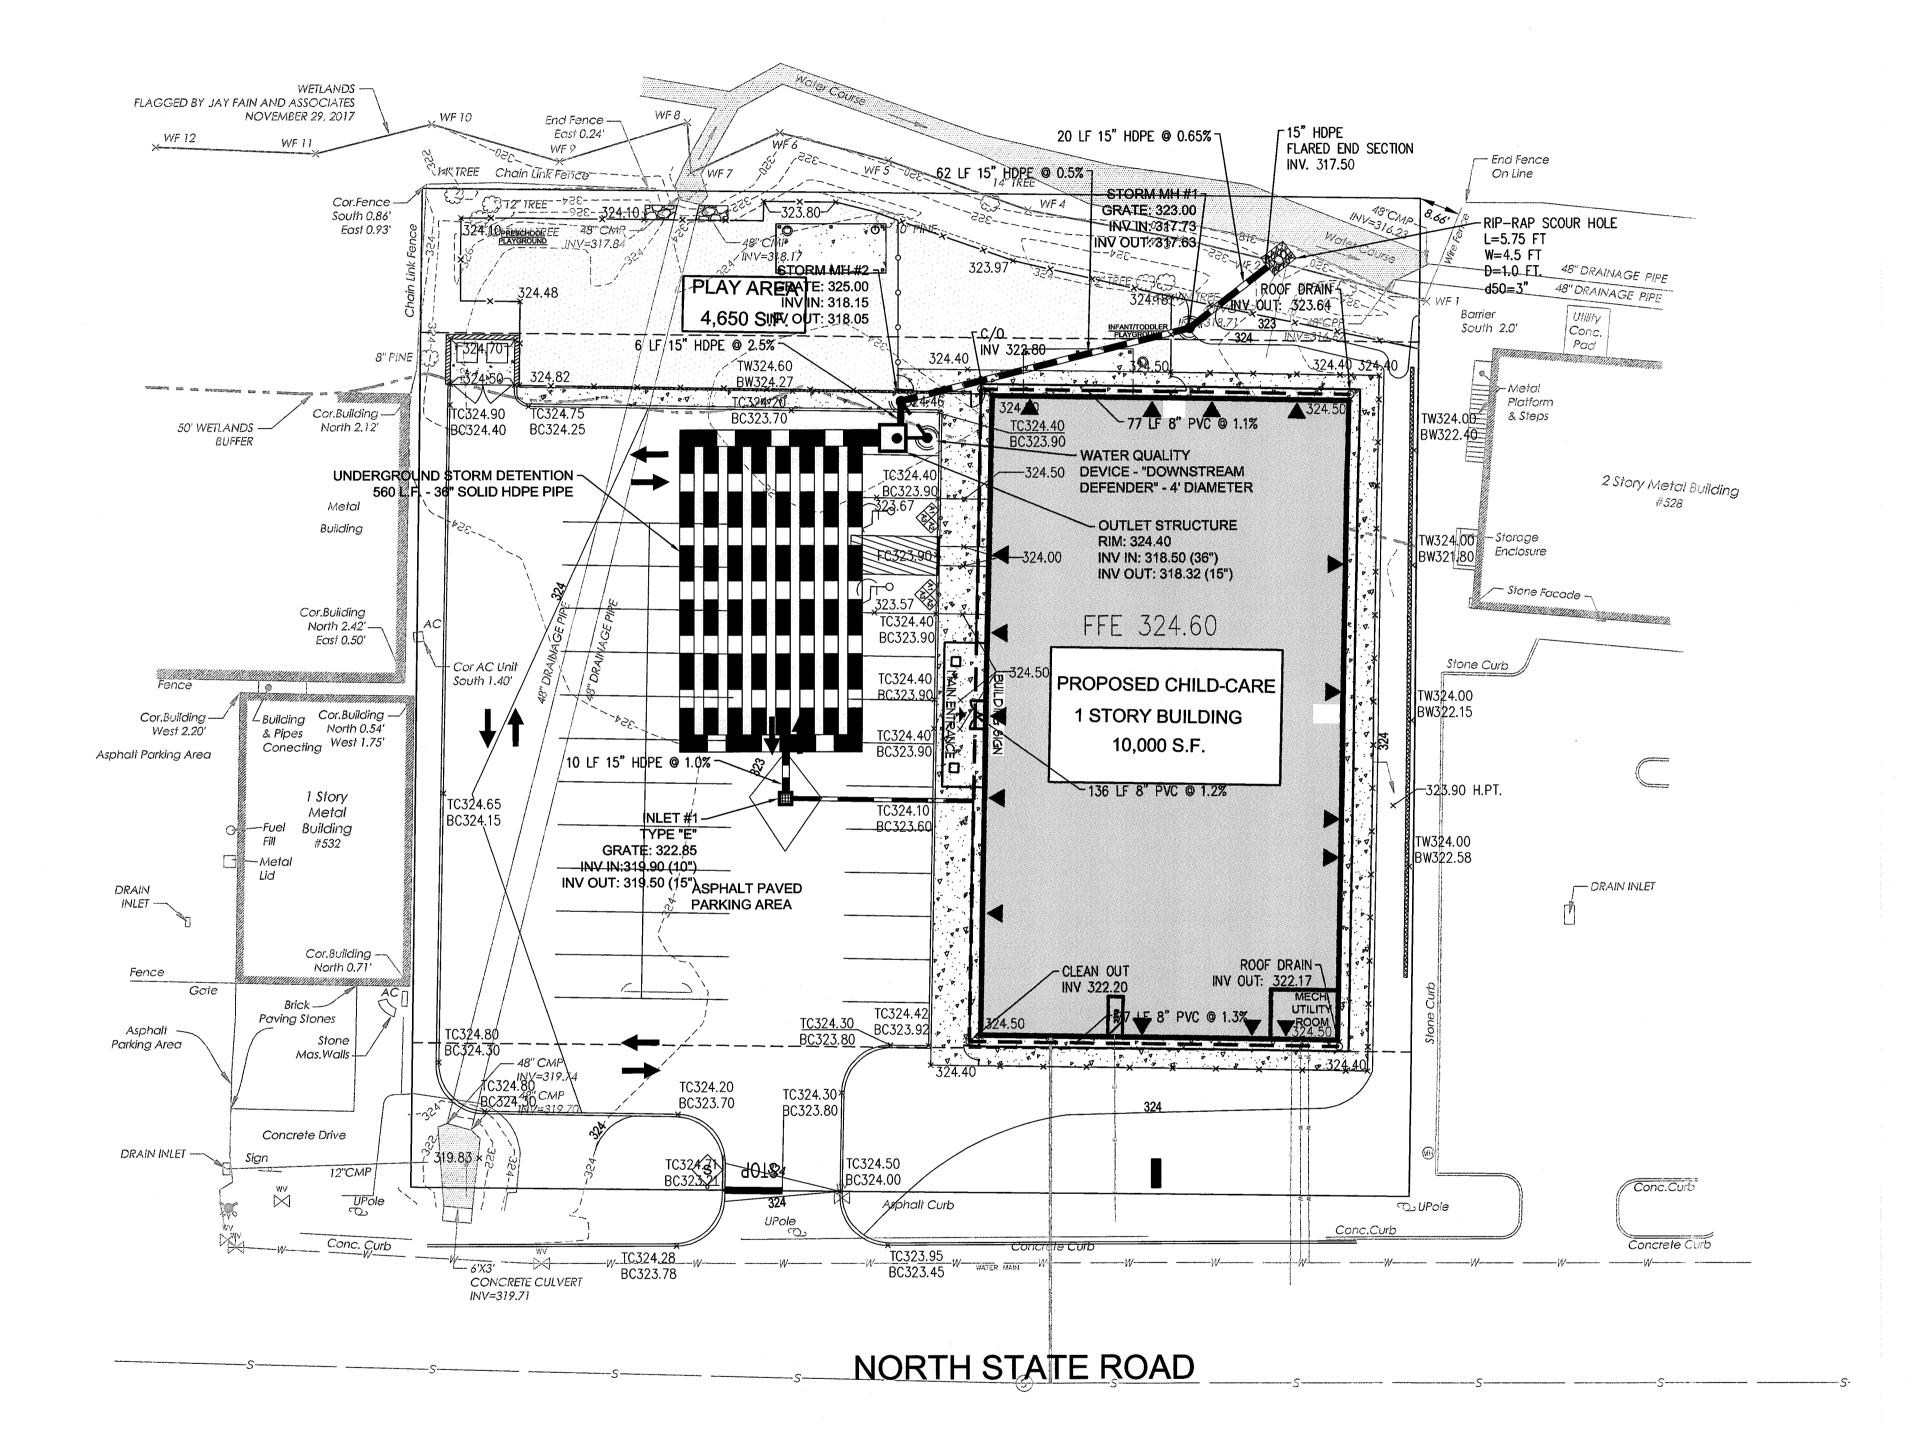

42 OKNER PARKWAY LIVINGSTON, NEW JERSEY 07039 TEL: 973-994-9669 FAX: 973-994-4069 www.jarmelkizel.com

Architecture Engineering Interior Design Implementation Services

		ISSUE	
NO.	DATE	DESCRIPTION	INT.
1.	5.23.18	INITIAL SUBMISSION	GPC
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	1.	REVISION	
NO.	DATE	DESCRIPTION	INT.

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DC LIC ARC101849	NY LIC 024673
DE LIC \$5-0007256	OH LIC A-99-12444
FL LIC AR94034	PA LIC RA-014851-B
GA LIC RA011484	RI LIC ARC.0004765
IA LIC 05577	SC LIC AR.9163
IL LIC 001.020069	TN LIC 103850 TX LIC 20992
MA LIC ARTUZOO	TX LIC 20992
MD LIC 12662 MI LIC 1301052189	VA LIC 0401 014089 VT LIC 2453
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CHERIE SCHWEINER, AIA	PA 11C PA407027

NJ State 8oard Of Architects Authorization No. 161 NJ Stote Boord Of Engineers & Lond Surveyors Authorization No. GA-27817 THE LEARNING EXPERIENCE 530 NORTH STATE ROAD TOWN OF OSSINING BRIARCLIFF MANOR, NY SECTION 90.15, BLOCK 2, LOT 18

TLENY-S-17-155 Approved By:

Drawing Name:


GRADING AND DRAINAGE PLAN

- 1. VERIFY THE LOCATION OF ALL UTILITY LINES PRIOR TO ANY PLANTING PIT EXCAVATION. CONTACT CALL BEFORE YOU DIG 72-HOURS PRIOR TO THE COMMENCEMENT OF ANY DIGGING OPERATIONS. COORDINATE BUILDER REGARDING UNDERGROUND SYSTEMS.
- 2. NOTIFY THE LANDSCAPE ARCHITECT AT LEAST FIVE (5) DAYS IN ADVANCE OF PLANT MATERIAL DELIVERY TO THE SITE.
- 3. LAYOUT ALL PLANT MATERIAL WITH THE LANDSCAPE ARCHITECT PRIOR TO PLANT PIT EXCAVATION. SET UP OF ALL MATERIAL IN BEDS REQUIRED FOR OWNERS AND LANDSCAPE ARCHITECTS APPROVAL PRIOR TO PLANTING.SEE PLAN FOR BED AND PLANT LAYOUT.
- 4. IF ANY DISCREPANCY OCCURS BETWEEN THE QUANTITIES CALLED FOR IN THE PLAN, NOTIFY THE LANDSCAPE ARCHITECT PRIOR TO BID.
- 5. ALL PLANT MATERIAL IS TO CONFORM TO THE REQUIREMENTS OF THE STANDARDS OF THE AMERICAN ASSOCIATION OF NURSERYMEN FOR EXTRA HEAVY GRADE UNLESS OTHERWISE SPECIFIED, TRUE TO NAME AND SIZE. INVESTIGATE SOURCES OF SUPPLY AND BE CERTAIN IT WILL BE POSSIBLE TO PROVIDE ALL PLANT MATERIALS SPECIFIED IN THE QUALITY AND QUANTITY REQUIRED PRIOR TO BIDDING.
- 6. ANY PLANT REQUIRED UNDER THIS CONTRACT THAT IS DEAD, DYING NOT TRUE TO NAME OF SIZE AS SPECIFIED OR NOT IN SATISFACTORY GROWTH, OR HAVING BRANCHED OR DEFORMED STRUCTURE DUE TO LOSS OF LIMBS OR BRANCHED AS DETERMINED BY THE LANDSCAPE ARCHITECT, THAT PLANT MUST BE REMOVED FROM THE PROJECT SITE AND REPLACED WITH AN APPROVED PLANT OF EQUAL SIZE AND SPECIES. PLANT VARIETY AND SIZE SUBSTITUTIONS WILL NOT BE PERMITTED UNLESS PROVED THAT THE SPECIFIED PLANT MATERIAL IS UNATTAINABLE OR CANNOT MEET SPECIFICATION REQUIREMENTS, THEN THE USE OF THE NEAREST EQUIVALENT SIZE OR VARIETY WILL BE CONSIDERED. PLANT MATERIAL LARGER THAN SPECIFIED MAY BE USED AT NO INCREASE IN COST. PROPOSED SUBSTITUTIONS MUST RECEIVE THE LANDSCAPE ARCHITECTS **AUTHORIZATION PRIOR TO BID.**
- 7. STAKE TREES ONLY AS NECESSARY TO INSURE STABILITY.
- 8. ALL STOCKPILED MATERIALS ARE TO BE STORED IN AN AREA WITH GOOD SURFACE DRAINAGE, SOIL BALLS ARE TO BE COVERED WITH MULCH AND PLANTS ARE TO BE WATERED FREQUENTLY TO KEEP SOILS BALLS MOIST.
- 9. ALL PLANT MATERIALS ARE TO BE GUARANTEED FOR A PERIOD OF ONE YEAR FROM THE DATE OF FINAL ACCEPTANCE AS DETERMINED BY THE LANDSCAPE ARCHITECT.
- 10. RESTORE ALL DISTURBED OR DAMAGED AREAS RESULTING FROM PLANTING OPERATIONS TO ORIGINAL CONDITIONS.
- 11. PROVIDE 4" SCREENED TOPSOIL IN ALL AREAS NOT TO BE PAVED AS NEEDED, USE OWNERS STOCKPILE/ EXISTING SOIL AS PRACTICAL. MULCH BED AREAS WITH 2" OF SHREDDED PINE BARK. PROVIDE SAMPLE OF MULCH FOR OWNER'S APPROVAL. PROVIDE PER YARD PLACE & SPREAD TOPSOIL PRICE.
- 12. SEE PLAN FOR LAWN LIMIT AND BED LAYOUT CUT BEDS AFTER APPROVAL FROM OWNER AND LANDSCAPE ARCHITECT. SEED OR SOD PER OCNTRACT LAWN AREAS AND MULCH NEW SEED WITH CHOPPED STRAW OR SALT HAY. PROVIDE STARTER FERTILIZER IN SEED MIX. SEED MIX, OR APPROVED EQUAL, AS FOLLOWS:
  - a. BLEND OF 3 TALL FESCUES FOR WATER AND FERTILIZER NEEDS REDUCTION, i.e. 'DEFIANCE XRE FESCUE GRASS SEED BLEND' CONTAINING SPEEDWAY, BLACKWATCH AND SR-8650 TALL FESCUES THAT ARE TURF FORMING AND SELF HEALING

Quan.	Sym.	Botanical/ Common Name	Size/Root	Remark
TREE				
1	AC	Amelanchier c. x. 'Autumn Brilliance' / Shadblow	2-2.5"cal/BB	1 buffer
2	CF	Cornus florida / Flowering Dogwood	1.75-2" Cal/ BB	buffer
SHRU	BS			
5	CA	Clethra alnifolia/ Sweet Pepperbush	#3/Cont.	buffer
5	IV	Itea virginana /Sweetspire	#3/ Cont.	buffer
б	MP	Myrica pensylvanica/Bayberry	#3 /Cont.	buffer
2	SD	Salix discolor/ Pussywillow	5-6' ht clump	buffer
FORE	IS			
7	At	Amsonia taberna/ Bluestar	2 gal	buffer
7	As	Ascelpias incarnata / Swamp milkweed	17:01	buffer
20	Apd	Aster n. 'Purple Dome'	1 gal	Buffer front
20	Ep	Echinacea purpurea/ Coneflower	1 gal	Buffer
20	Ha	Heuchera americana / Coral bells	1 gal	Buffer front
20	R	Rudebeckia f. 'Goldsturm'/ Blackeyed Susan	1 gal	buffer
GRA8	SES			
26	Pv	Panicum virgatum 'Northwind' /Switchgrass	2 gal	buffer
14	Ss	Schizachyrium scoparium / Little Bluestem 'The Blues'	2 gal	front
20	Sh	Sporobolus heterolepsis/ Praire Dropseed	1 gal	Buffer front
	NT Sym.	ox proposed on cedar post.  LIST for Non Buffer areas  Botanical/ Common Name	(Native and deer	resistant)
5	AC	Amelanchier c. x. 'Autumn Brilliance' / Shadblow	2-2.5"cal/BB	1 buffer and 5
3	ov	Ostrya virginiana / American Hophombeam	2-2.5" cal/BB	Trees in front- matching
n	TP	Thuja p. 'Green Giant'	6-7' ht/BB	Screen at side
<b>D</b>				<u> </u>
	···	Comus sericea / Redtwig Dogwood	#3 Cont.	front
SHRU	CS		<del></del>	
SHRU 9	CS PF	Potentilla fruticosa 'Goldfinger'	#5 Cont.	Front
S <b>HRU</b> 9 7	<del></del>	Potentilla fruticosa 'Goldfinger'	<del>4</del>	Front Front
<b>SHRU</b> 9 7 6	PF HA	<u> </u>	#5 Cont. #5 cont.	Front Front
8 SHRU 9 7 6 FORE 6	PF HA	Potentilla fruticosa 'Goldfinger'	<del>4</del>	. <b> </b>


## GENERAL NOTES

- 1. LANDSCAPE AND WETLAND MITIGATION PLAN FOR PLANTING ONLY.
- 2. FOR ALL OTHER SITE PLAN INFORMATION, REFER TO DRAWING SET DATED APRIL 27, 2018, PROVIDED BY JARMEL KIZEL ARCHITECTS AND ENGINEERS, INC., TITLED PRELIMINARY/FINAL SITE PLAN THE LEARNING EXPERIENCE, SHEETS 1-11.

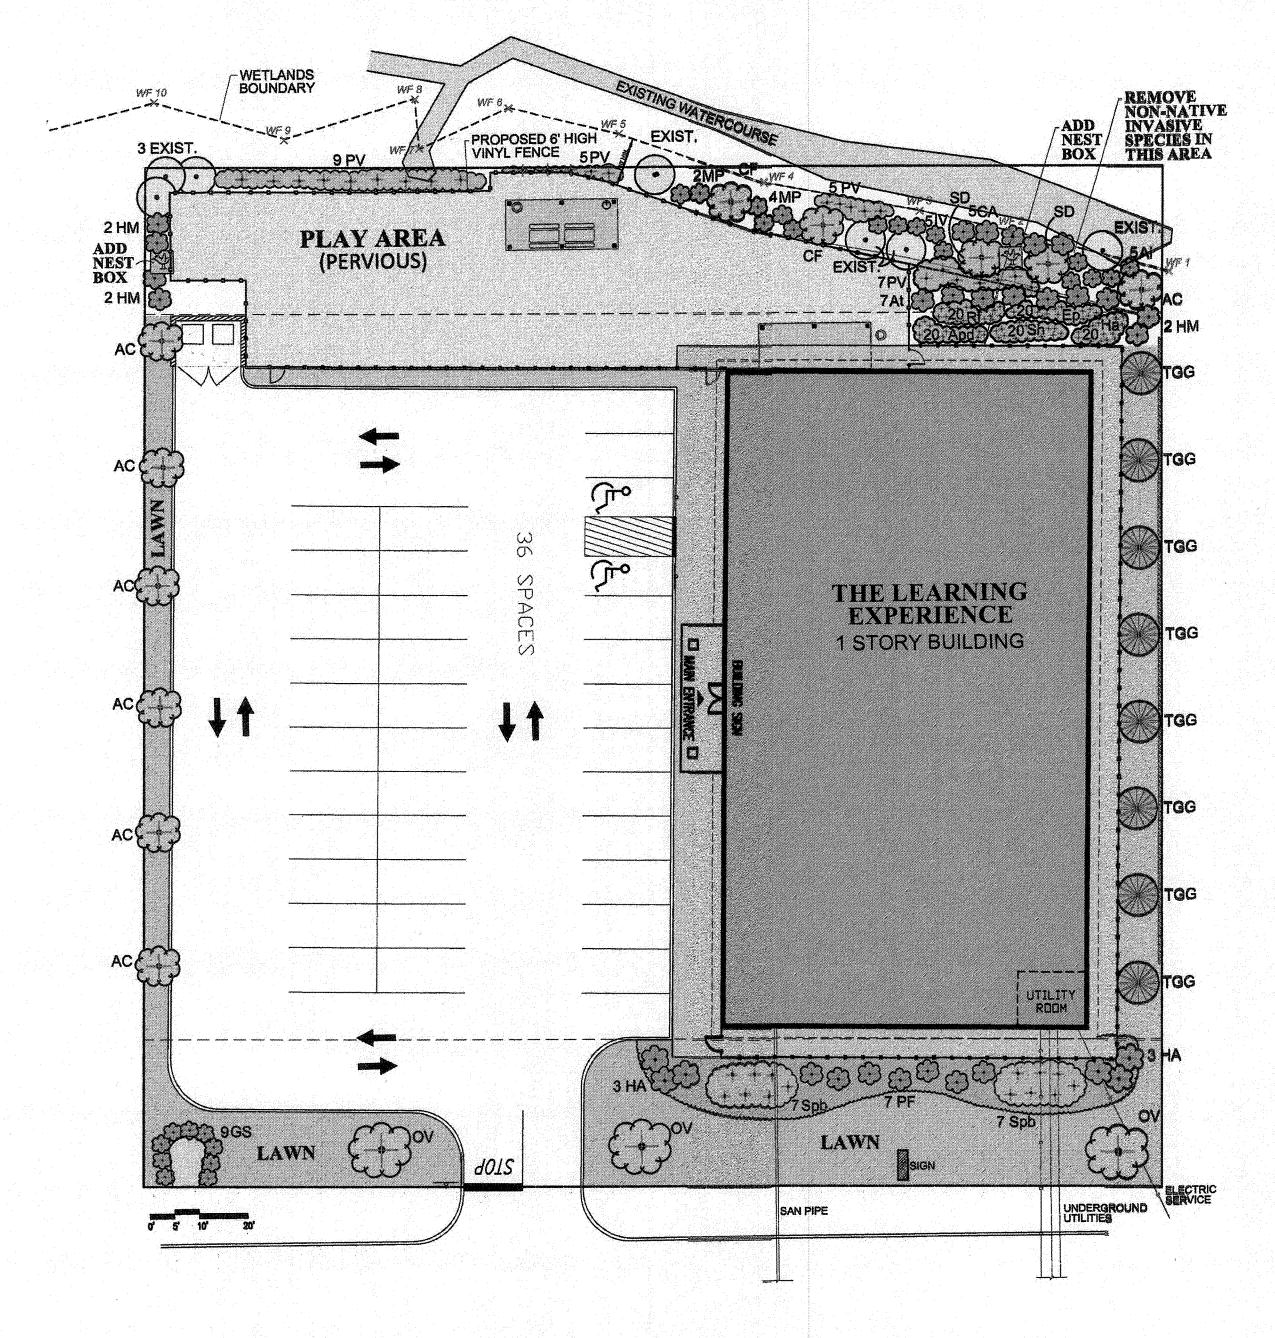



LANDSCAPE AND WETLAND MITIGATION I	PLAN
530 NORTH STATE ROAD BRIARCLIFF MANOR, NY	Date: 05-22-18
AY FAIN & ASSOCIATES, LLC Environmental Consulting Services  134 Round Hill Road Fairfield, CT 06824 203-254-3156 - fax: 203-254-3167	Sheet No.:

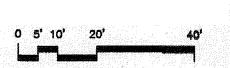

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Implementation Services

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		REVISION				
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FIXINGIFALS	
MATTHEW B. JARMEL, AIA, MBA	NJ LIC AI0-12787
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ČŤ ĽČ ÁŘI,0011415	NH LIC 3501
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OT UC EN0027735	NJ LIC 37491 MN LIC 47482 NY LIC 073898-1 PA LIC PE070600 MA LIC 50445
[] HG 20134 = 2330	NY LIC 073898-1
NE HE PAYAZ	MA UC 50445
	TX LIC 123822
ASSUCIATES	
RONALD A. BROKENSHIRE PE OT LIC PEN:0032811	NJ LIC GE45511 PA LIC PE085817
GT LIG PEN. GUSZ811	
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	TA LIC RA40/92/
NI State Beard Of Architects Aut	horization No. 161
NJ State Board Of Architects Aut IJ State Board Of Engineers & Land Surveyor	Authorization No. GA-27817
Project: THE LEARNING E	
530 NORTH STA	TE ROAD
TOWN OF OSS	
DDIAD/I IEF MA	NOR NY



#### Autobahn Series ATB0 **Roadway Lighting**

Same Light: Performance is comparable to 70-200W HPS roadway luminaires. White Light: Correlated color temperature - 4000K, 70 CRI minimum, 3000K,

Unique IP66 rated LEO light engines provided 0% uplight and restrict backlight to within sidewalk depth, providing optimal application coverage and optimal pole spacing. Available in Type II, III, IV, and V roadway distributions.

Expected Life: LED light engines are rated >100,000 hours at 25°C, L70.

Electronic driver has an expected life of 100,000 hours at a 25°C ambient. Lower Energy: Saves an expected of 40-60% over comparable HID luminaires. Robust Surge Protection: Three different surge protection options provide a minimum of IEEE/ANSI C62.41 Category C (10kV/5kA) protection. 20kV/10kA

Includes standard AEL lineman-friendly features such as tool-less entry, 3

Rugged die-cast aluminum housing and door are polyester powder-coated

(operated per ASTM B117). Optional Enhanced Corrosion Resistant finish (CR)

Mast arm mount is adjustable for arms from 1-1/4" to 2" (1-5/8" to 2-3/8" 0.0.)

NEMA 3 pin photocontrol receptacle is standard, with the Acuity designed ANSI standard 5 pin and 7 pin receptacles optionally available.

Premium solid state locking style photocontrol - PCSS (10 year rated life) Extreme long life solid state locking style photocontrol - PCLL (20 year rated

Multi-level dimming available to provide scheduled dimming as specified by

Optional onboard Adjustable Output module allows the light output and input wattage to be modified to meet site specific requirements, and also can allow a single fixture to be flexibly applied in many different applications.

DesignLights Consortium® (DLC) qualified product. Not all versions of this

www.designlights.org/QPL to confirm which versions are qualified.

product may be DLC qualified. Please check the DLC Qualified Products List at

for durability and corrosion resistance. Rigorous five-stage pre-treating

and painting process yields a finish that achieves a scribe creepage rating of 8 (per ASTM D1654) after over 1000 hours exposure to salt fog chamber

electrical compartment for easily leveling at installation.

increases the salt spray exposure over 5000 hours.

diameter. Provides a 3G vibration rating per ANSI C136.31 Wildlife shield is cast into the housing (not a separate piece).


station terminal block and quick disconnects. Bubble level located inside the

70 CRI minimum or optional 5000K, 70 CRI minimum.

protection is also available.

Applications:

Residential streets Parking lots

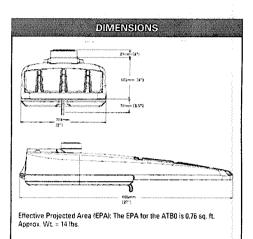

CSA Certified to U.S. and Canadian standards Complies with ANSI: C136.2, C136.10, C136.14, C136.31, C136.15, C136.37

Note: Specifications subject to change without notice. Actual performance may differ as a result of end-user environment and application.

American Electric Lighting

The optical I.E.S. distribution options must

 Motion Sensor / Ambient Photocontrol with mounting options ranging from (8-15') and

Title 24 compliance options available

Suitable for operation in an ambient temperature up to 40°C / 104°F for standard

DesignLights Consortium® (DLC) qualified product. Not all versions of this product may

be based only on IES LM-B0-0B and TM-21


Warranty - 5 Years Limited
Complete warranty terms located at:

be DLC qualified. Please check the DLC www.designlights.org/QPL to confirm which versions are qualified.

Optic Material Options

A zero uplight option (FC)

Type V: E (entry), M (medium), R (rectangle) &

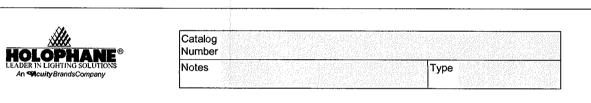

FEATURES & SPECIFICATIONS

Rated for -40°C to 40°C ambient

## Parkpak<sup>®</sup> LED

© 2014-2016 Acuity Brands Lighting, Inc. 08/01/16

Mechanical Specifications

Heavy grade A3B0 cast aluminum or equivalent coupled with a rigorous S-stage pretreatment, epoxy basecoat and polyester topcoat yield a finish

that achieves a scribe creepage rating of B after S,000 hours of salt spray. Mount to a standard junction box Provide a swivel kit for pendant mount application

 $\frac{3}{4}$ " threaded plug ( $\frac{3}{4}$ " - 14 NPT) on each side, accepts 3/4" and 1/2" conduit.

Vibe rating for surface mount: 3G Pendant mount: ¾" - 14 NPT in center of housing
 Bird shroud

 Electrical Specifications
 Electrical harness for quick and safe disconnect / connect of power and options
Certified drivers, UL or CSA
Rated for -40°C / -40°F minimum ambient Programmable electronic driver with 0-10V control

Available in: 120-277V S0/60 Hz and 347-480V ndard LEDs shall have a minimum of 70 CRI Optional LEDs shall have a minimum of 80 CRI available in 3000K, 4000K and S000K CCT (B week


lead-time)
Internal mounted emergency battery backup for operation in an ambient temperature ranging from -20°C / -4°F to 30°C / 86°F for P10 thru P40 rformance packages, non CEC compliant The electrical system shall be designed to meet


ANSI/IEEE C62.41.2 and shall offer a 10kV/SkA SPD

DIMENSIONAL DATA

/ 3825 Columbus Rd., Granville, OH 43023 / Phone: 866-HQLOPHANÉ / www.holophane.com

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NORTH STATE ROAD

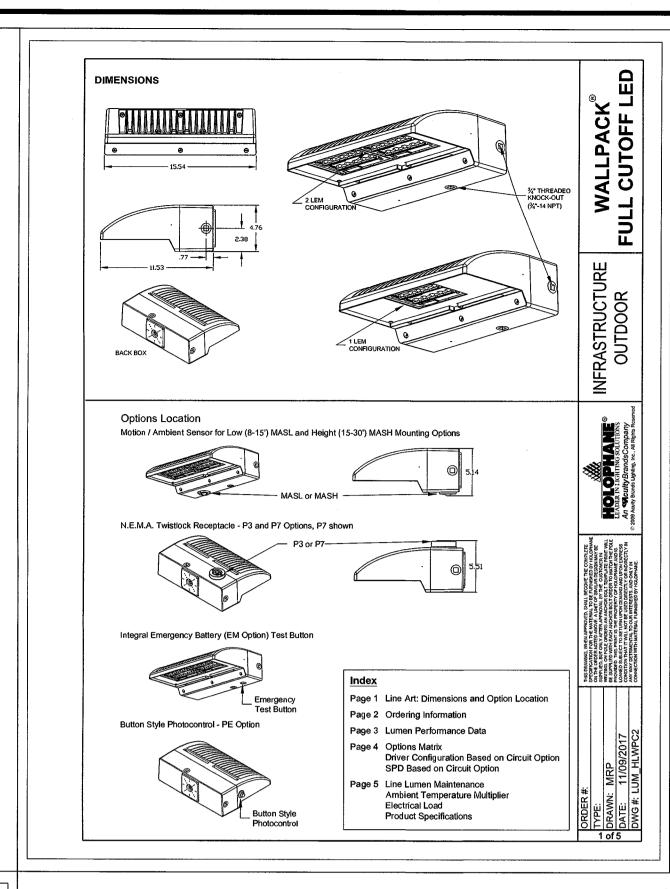Lun	ninaire	Location	ns							
Location							·	Aim		
No.	Label	х	Y	z	мн	Orientation	Tilt	х	Y	z
1	Α	135.91	30.90	8.00	8.00	180.00	0.00	135.91	30.40	0.0
2	Α	171.54	30.40	8.00	8.00	180.00	0.00	171.54	29.90	0.0
3	Α	138.06	165.42	10.00	10.00	0.00	0.00	138.06	165.92	0.0
4	В	49.39	129.69	16.00	16.00	90.00	0.00	51.14	129.69	0.00
5	В	48.07	48.67	16.00	16.00	90.00	0.00	49.82	48.67	0.00
6	Α	118.32	59.95	10.00	10.00	270.00	0.00	117.82	59.95	0.00
7	A	119.63	138.05	10.00	10.00	270.00	0.00	119.13	138.05	0.00
9	С	115.39	98.61	11.50	11.50	0.00	0.00	115.39	98.61	0.00

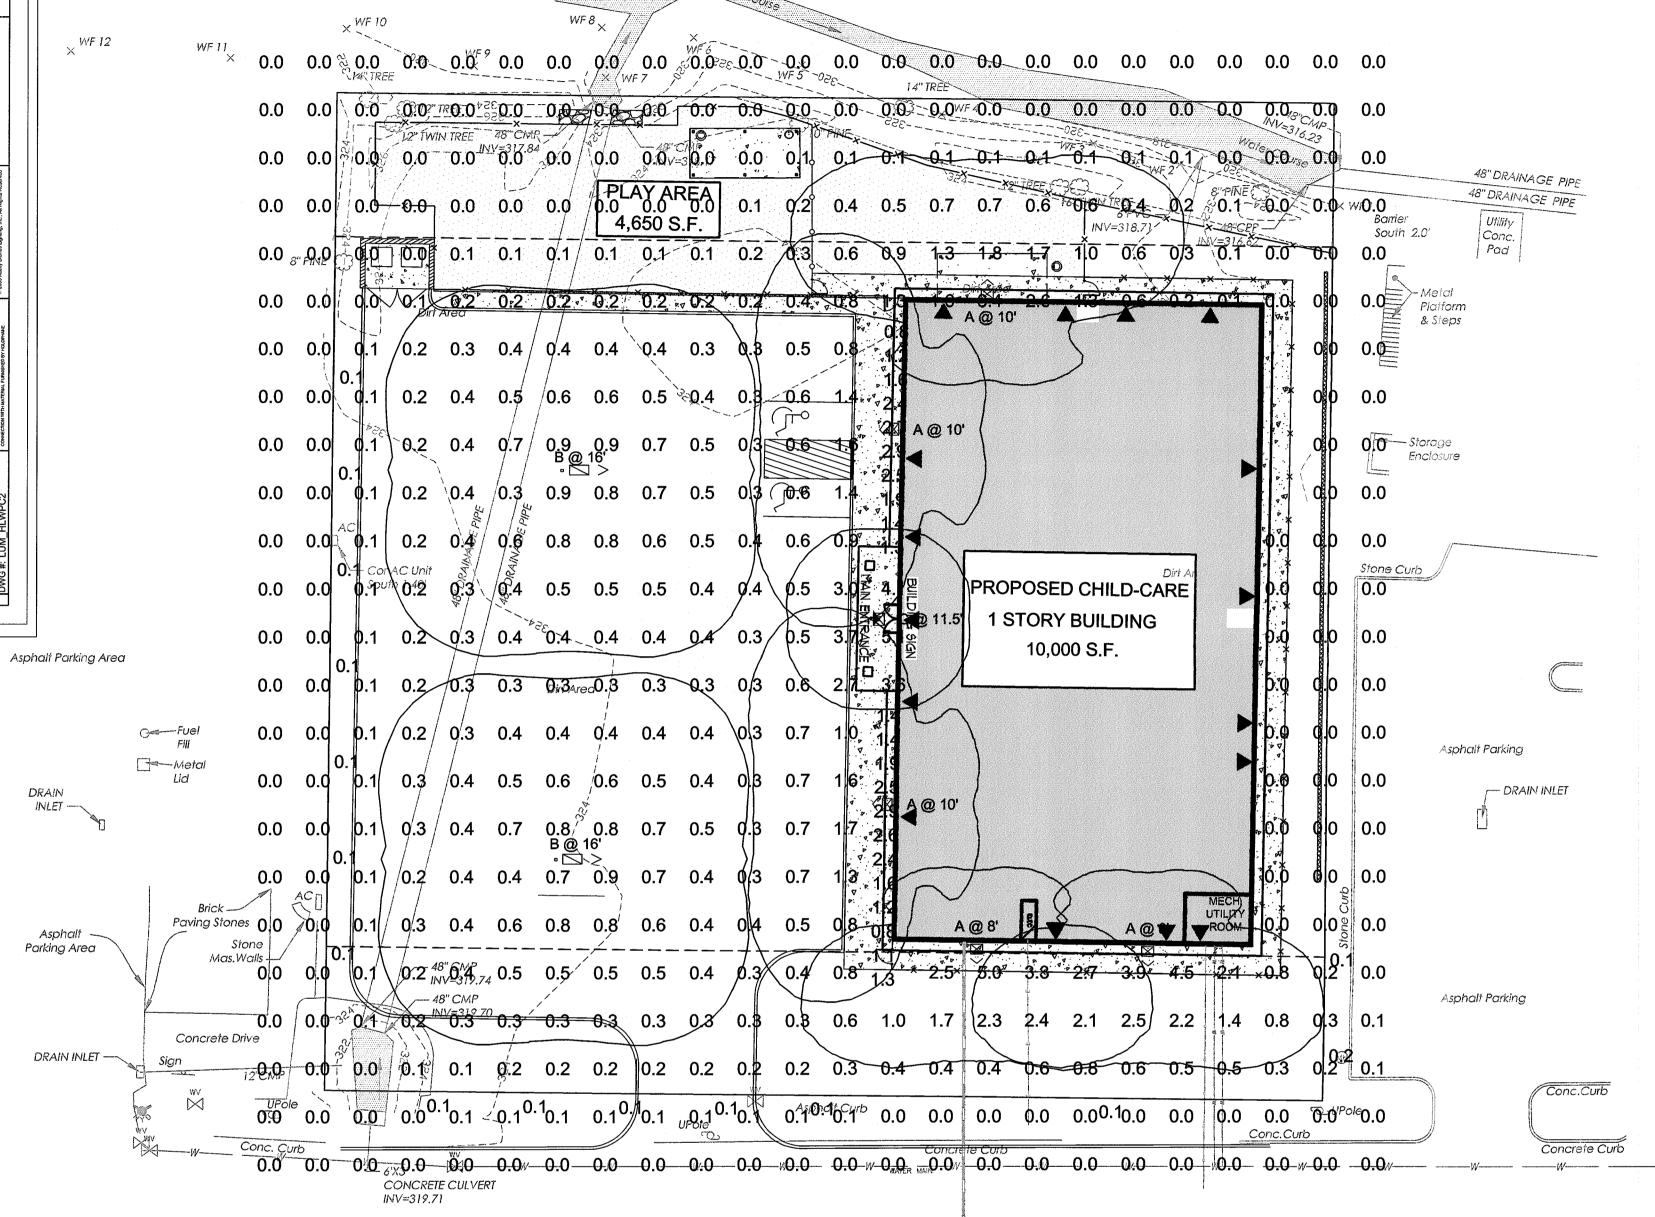1. Readings shown are based on a total LLF of as shown at grade. Data references the extrapolated performance projections in a 25c ambient based on 10,000 hrs of LED testing (per IESNA LM-80-08 and projected per IESNA TM-21-11).


2. Please refer to the "luminaire locations" for mounting heights.

3. Product information can be obtained at www.Holophane.com or through your local agency.

Statistics	<del></del>			· · · · · · · · · · · · · · · · · · ·		
Description	Symbol	<b>Av</b> g	Max	Min	Max/Min	Avg/Min
Approximate Property Line	*	0.0 fc	0.2 fc	0.0 fc	N/A	N/A
PARKING SUMMARY		0.6 fc	3.7 fc	0.2 fc	18.5:1	3.0:1
SIDEWALK	$\Diamond$	1.8 fc	2.9 fc	0.8 fc	3.6:1	2.3:1
SPILL LIGHT SUMMARY	+	0.4 fc	5.1 fc	0.0 fc	N/A	N/A

Schedule											
Symbol	Label	Quantity	Manufacturer	Catalog Number	Description	Lamp	Number Lamps	Filename	Lumens Per Lamp	Light Loss Factor	Wattage
$\widehat{\boxtimes}$	Α	5	Holophane	HLWPC2 P10 40K XX T3M	Wallpack Full Cutoff LED, LED Performance Package P10, 4000 series CCT, Voltage, Type III Medium	LED	1	HLWPC2_P10_40K_XX_T3M.i es	3017	0.92	28
^	В	2	American Electric Lighting	ATB0 10BLEDE70 XXXXX R5 4K/5K	ATB0 SERIES LED 700MA TYPE 5 4000K/5000K CCT	LED Array		ATB0_10BLEDE70_XXXXX_R 5_4K_5K.ies	3065	0.98	25
	С	1	Holophane	PPSQL2 P10 40K/50K XX FC T5E	Holophane ParkPak Square LED, LED Performance Package P10, 25W, 4000K/5000K CCT, Voltage, Zero uplight, Type V, Entryway	LED		PPSQL2_P10_40K_50K_XX_F C_T5E.ies	3133	0.93	25

Please note this analysis does not comply with minimal IESNA levels for parking and pedestrian safety. Acuity Brands will not be liable for any safety issues that may arise from the installation of the design.

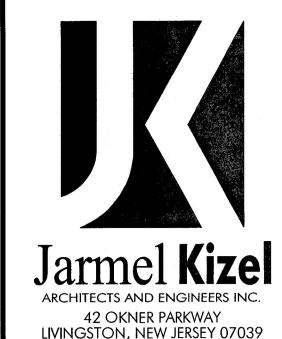

Architecture Engineering Interior Design Implementation Services

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PRINCIPALS	
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DC LIC ARC101849	NY LIC 024673
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IA LIC 05577	SC LIC AR.9163
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MD LIC 12662	VA LIC 0401 014089
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MA LIC 31425	PA LIC RA-405081
MICHAEL J. VORLAND, RA	NY LIC 036993

NJ LIC 21AI02069000 PA LIC RA407927 NJ State 8oard Of Architects Authorization No. 161 NJ 5tate Board Of Engineers & Lond Surveyors Authorization No. GA-27817 oject: THE LEARNING EXPERIENCE 530 NORTH STATE ROAD TOWN OF OSSINING


NJ LIC GE038255 NJ LIC 21A1018294 NJ LIC AI 8883 NY LIC 019151

Project No:	Scale:	
TLENY-S-17-155		1" = 20'
Drawn By:	Approved By:	
LB		RAJ

**BRIARCLIFF MANOR, NY SECTION 90.15, BLOCK 2, LOT 18** 

Drawing Name: LIGHTING PLAN


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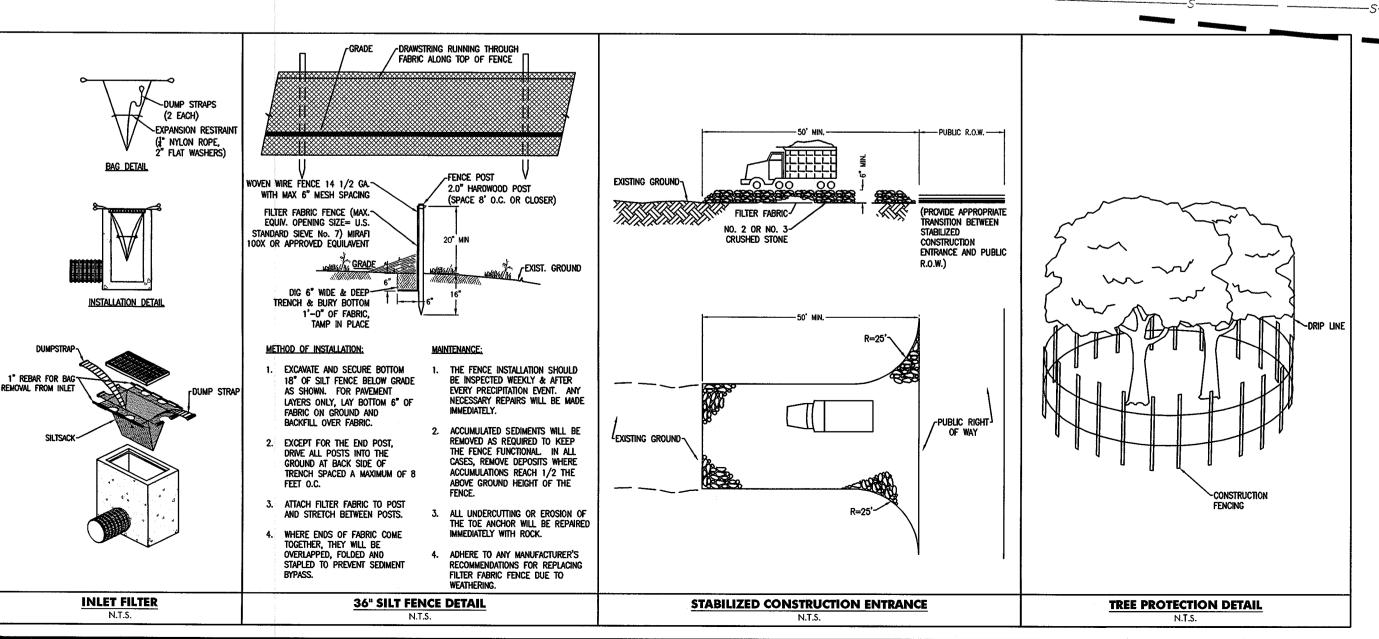


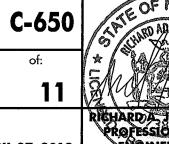



#### SOIL EROSION AND SEDIMENT CONTROL NOTES:

- 1. ALL SOIL EROSION AND SEDIMENT CONTROL PRACTICES SHALL BE INSTALLED PRIOR TO ANY MAJOR SOIL DISTURBANCES, OR IN THEIR PROPER SEQUENCE AND MAINTAINED UNTIL PERMANENT PROTECTION IS ESTABLISHED.
- 2. ANY DISTURBED AREAS THAT WILL BE LEFT EXPOSED MORE THAN 30 DAYS AND NOT SUBJECT TO CONSTRUCTION TRAFFIC, WILL IMMEDIATELY RECEIVE A TEMPORARY SEEDING. IF THE SEASON PREVENTS THE ESTABLISHMENT OF A TEMPORARY COVER, THE DISTURBED AREAS WILL BE MULCHED WITH STRAW, OR EQUIVALENT MATERIAL, AT A RATE OF TWO (2) TONS PER ACRE, ACCORDING TO NY STATE STANDARDS.
- 3. PERMANENT VEGETATION SHALL BE SEEDED OR SODDED ON ALL EXPOSED AREAS WITHIN TEN (10) DAYS AFTER FINAL GRADING. MULCH WILL BE USED FOR PROTECTION UNTIL SEEDING IS ESTABLISHED.
- 4. ALL WORK SHALL BE DONE IN ACCORDANCE WITH THE NEW YORK STATE STANDARDS FOR SOIL EROSION AND SEDIMENT CONTROL.
- 5. ALL WORK WITHIN COUNTY RIGHT-OF-WAY SHALL BE DONE IN ACCORDANCE WITH NASSAU COUNTY RULES AND REGULATIONS.
- 6. A SUB-BASE COURSE WILL BE APPLIED IMMEDIATELY FOLLOWING ROUGH GRADING AND INSTALLATION OF IMPROVEMENTS IN ORDER TO STABILIZE STREETS, ROADS, DRIVEWAYS AND PARKING AREAS. IN AREAS WHERE NO UTILITIES ARE PRESENT, THE SUB-BASE SHALL BE INSTALLED WITHIN 15 DAYS OR PRELIMINARY GRADING.
- 7. AT THE TIME WHEN THE SITE PREPARATION FOR PERMANENT VEGETATIVE STABILIZATION IS GOING TO BE ACCOMPLISHED, ANY SOIL THAT WILL NOT PROVIDE A SUITABLE ENVIRONMENT TO SUPPORT ADEQUATE VEGETATIVE GROUND COVER. SHALL BE REMOVED OR TREATED IN SUCH A WAY THAT WILL PERMANENTLY ADJUST THE SOIL CONDITIONS AND RENDER IT SUITABLE FOR VEGETATIVE GROUND COVER. IF THE REMOVAL OR TREATMENT OF THE SOIL WILL NOT PROVIDE SUITABLE CONDITIONS, NON-VEGETATIVE MEANS OF PERMANENT GROUND STABILIZATION WILL HAVE TO BE EMPLOYED.
- 8. CONTRACTOR IS RESPONSIBLE FOR KEEPING ALL ADJACENT ROADS CLEAN DURING LIFE OF CONSTRUCTION OF
- 9. THE DEVELOPER SHALL BE RESPONSIBLE FOR REMEDIATING ANY EROSION OR SEDIMENT PROBLEMS THAT ARISE AS A RESULT OF ONGOING CONSTRUCTION AT THE REQUEST OF THE SOMERSET-UNION SOIL CONSERVATION



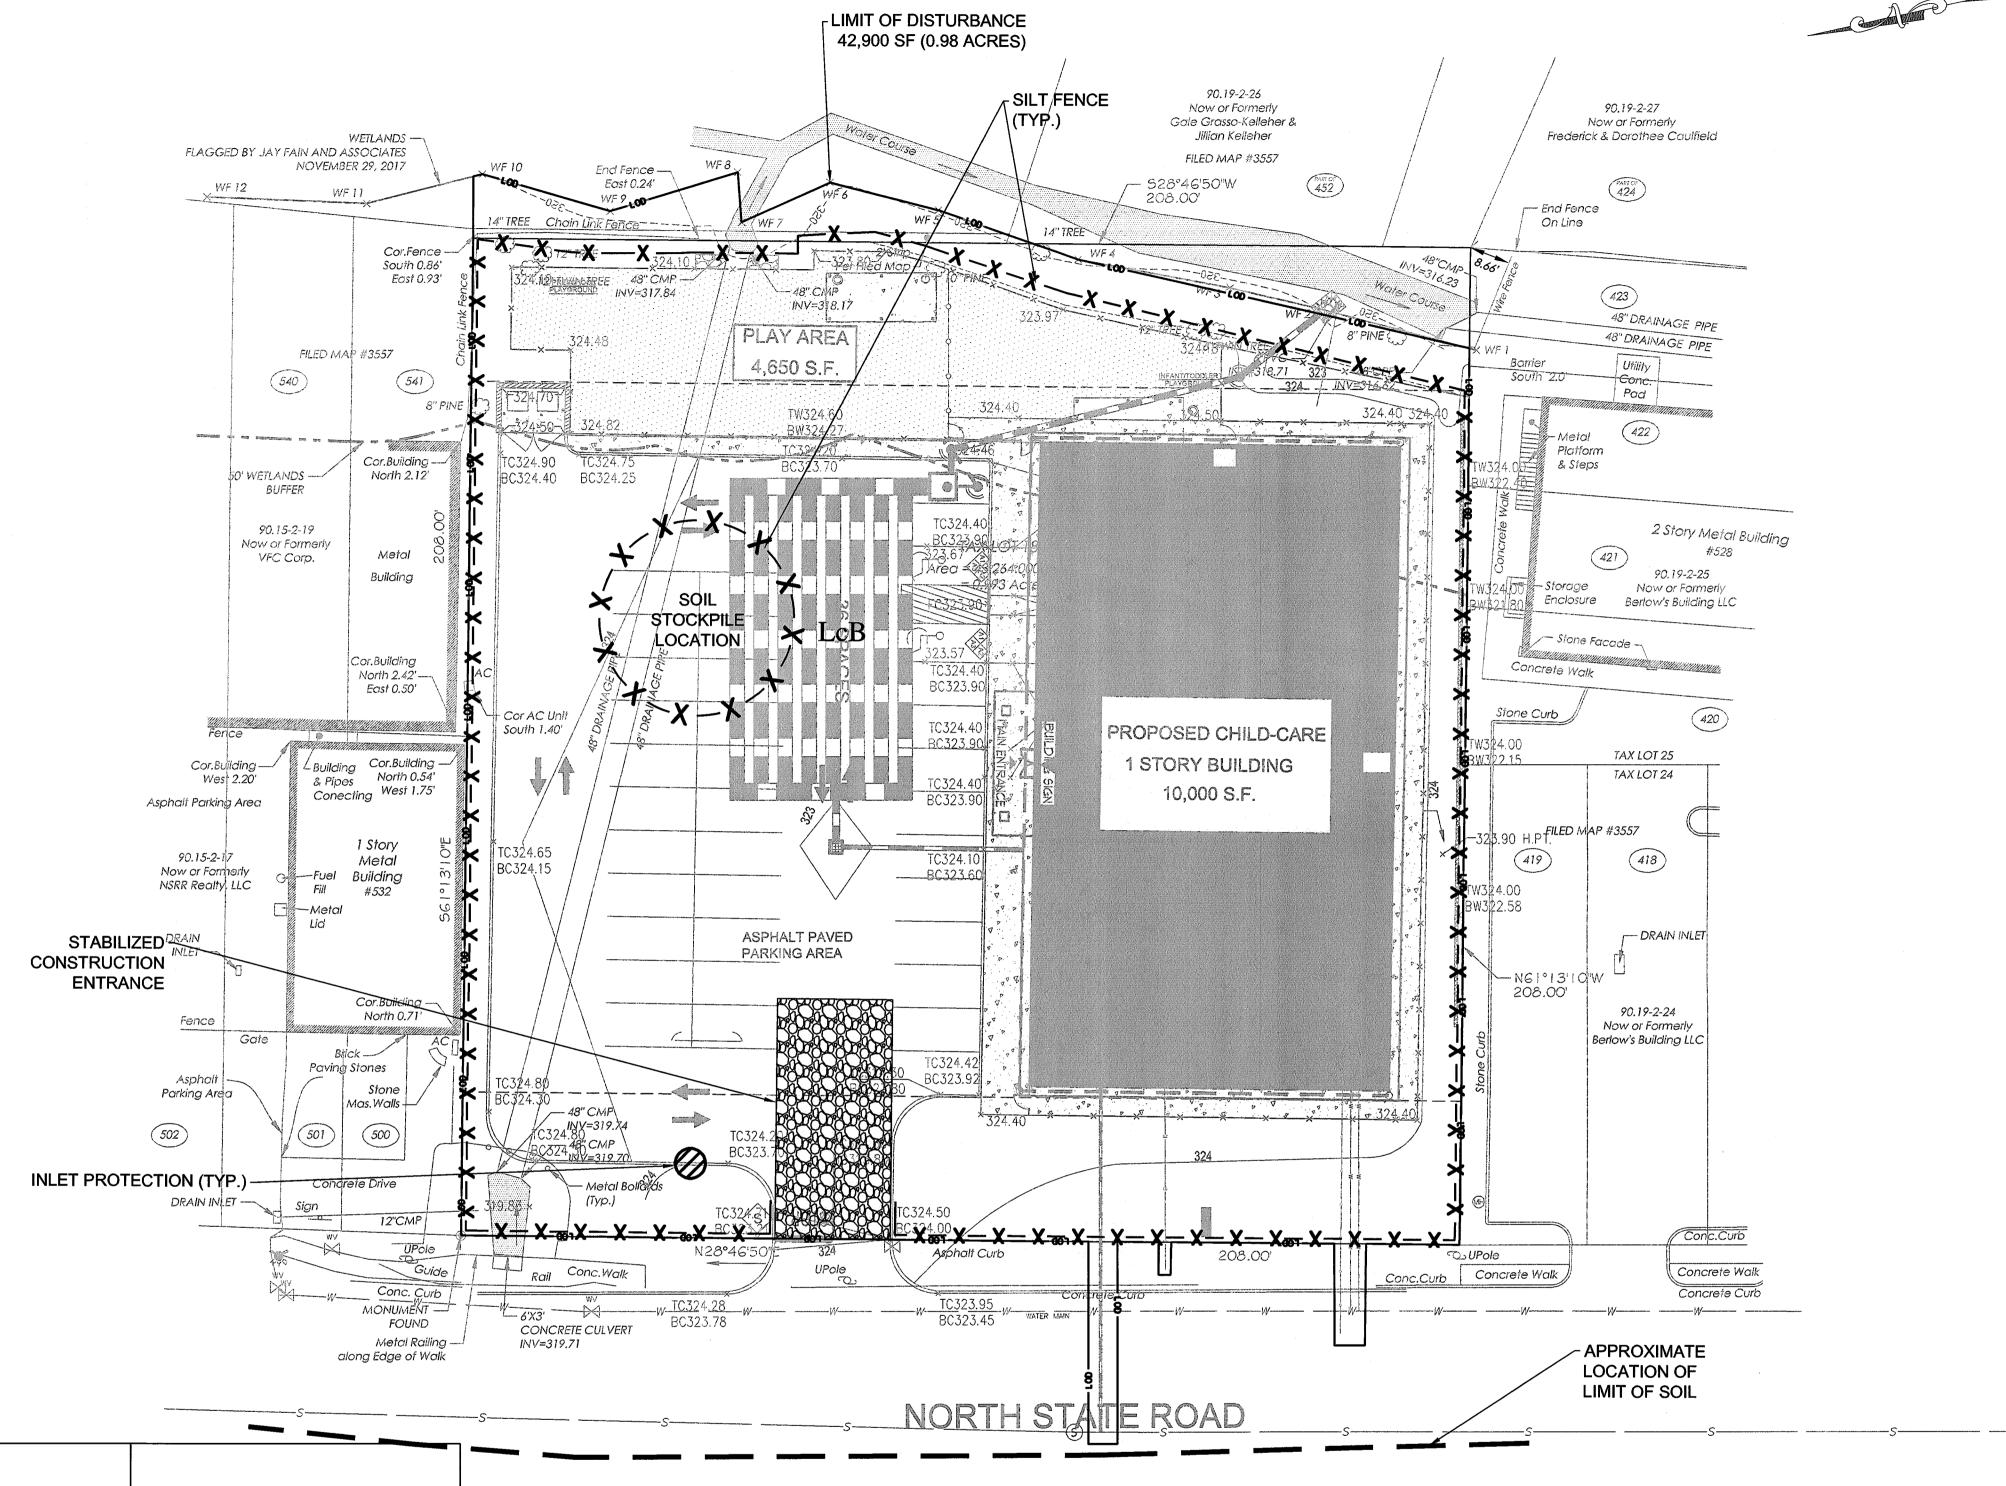

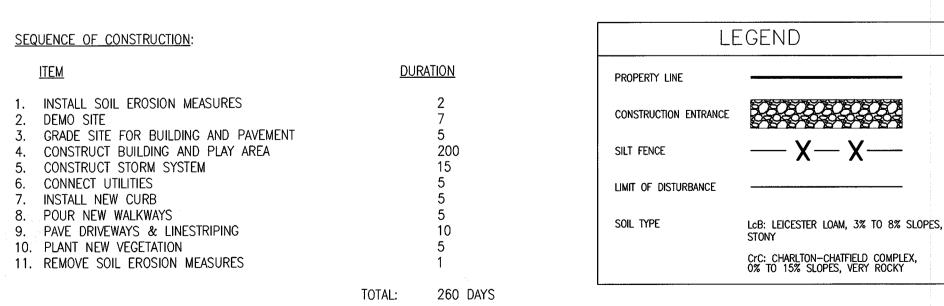

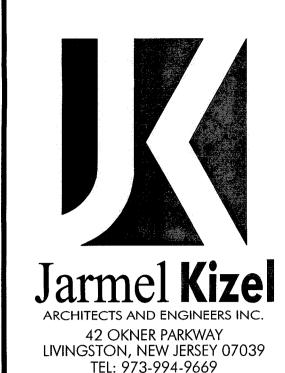

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IA LIC 05577

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MA LIC AR10286

MD LIC 12662

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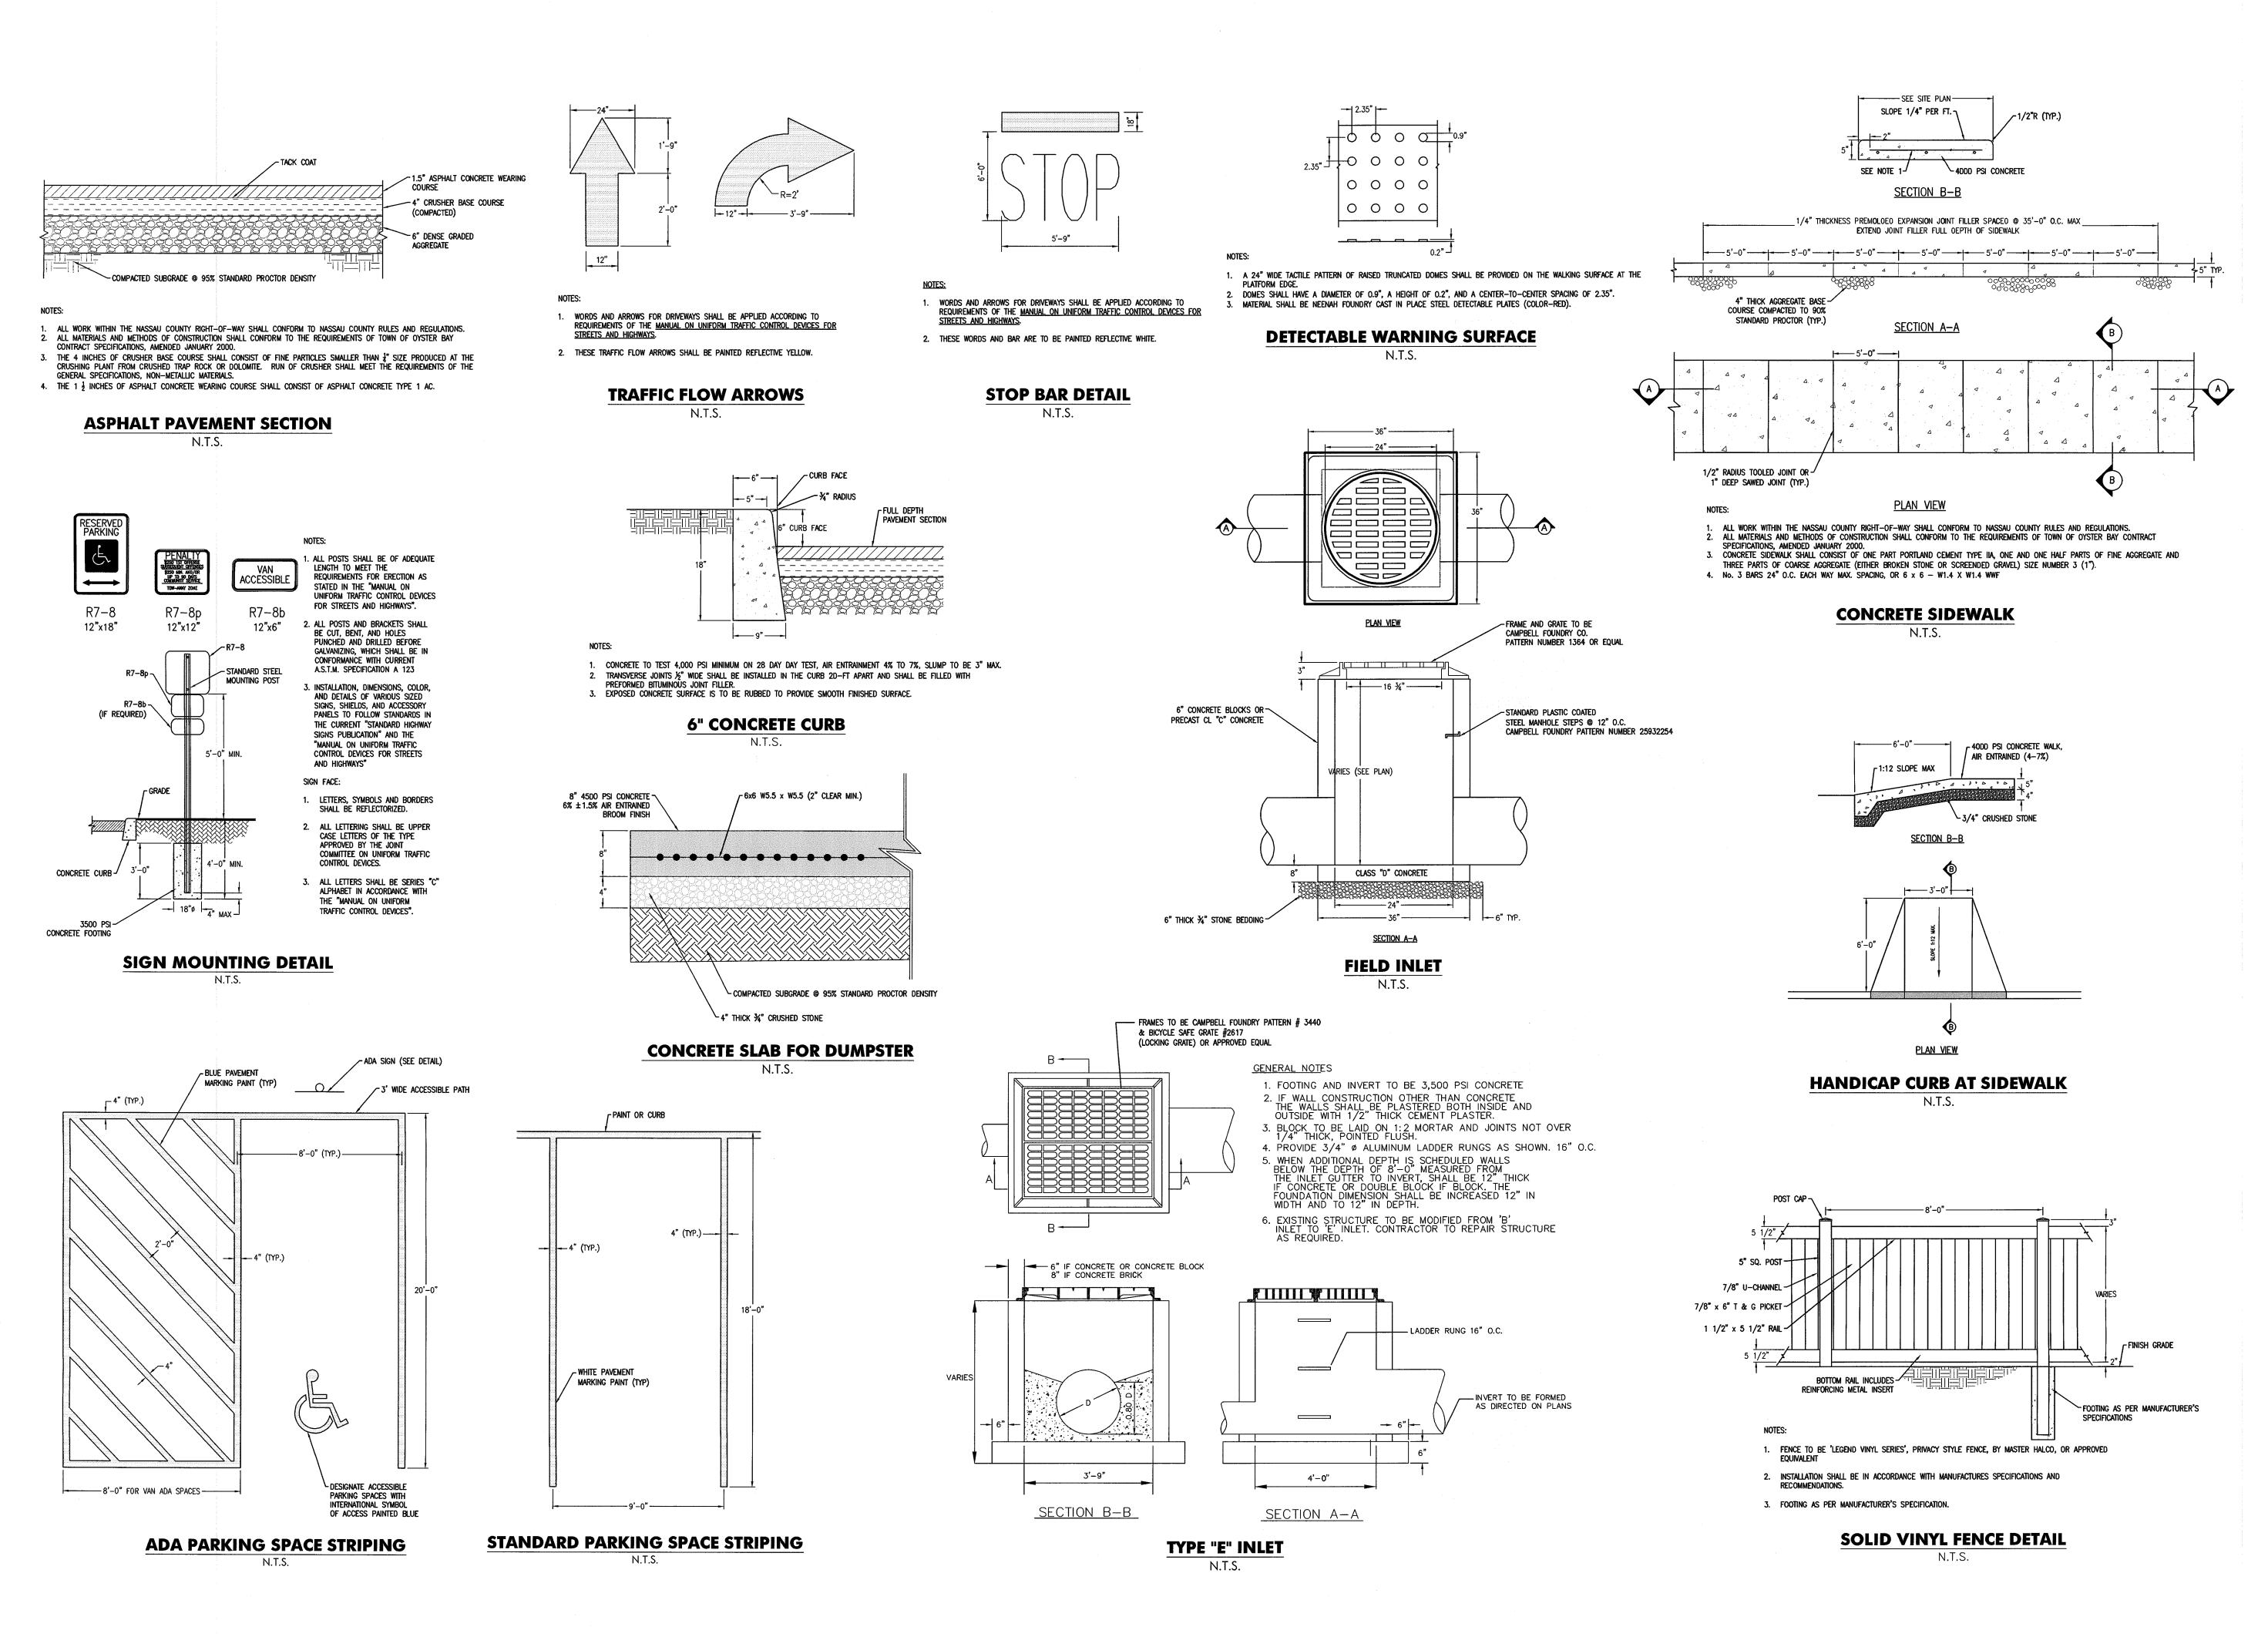
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NJ LIC GE038255 PA LIC 016502-B CHERYL SCHWEIKER, AIA NJ LIC 21AI02069000 PA LIC RA407927 NJ State Board Of Architects Authorization Na. 161 NJ State Board Of Engineers & Lond Surveyars Authorization No. GA-278177

Project: THE LEARNING EXPERIENCE 530 NORTH STATE ROAD TOWN OF OSSINING BRIARCLIFF MANOR, NY SECTION 90.15, BLOCK 2, LOT 18

1" = 20 TLENY-S-17-155 Approved By:

SOIL EROSION AND SEDIMENT CONTROL PLAN




Jarmel Kize

ARCHITECTS AND ENGINEERS INC.

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CT LIC ARI-0011748

MA LIC 31 425

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NJ LIC AI0-12787

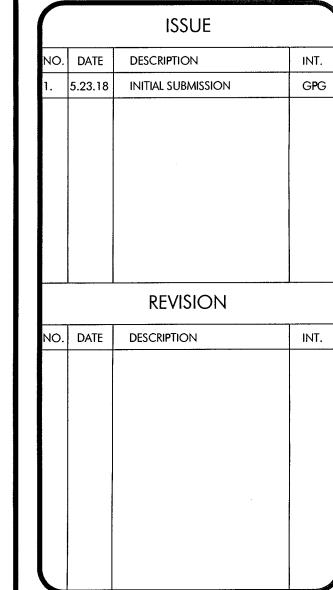PRINCIPALS
MATTHEW B. JARMEL, AIA, MBA

NJ State Board Of Architects Authorization No. 161
NJ State Board Of Engineers & Land Surveyors Authorization No. GA-27817

Project: THE LEARNING EXPERIENCE
530 NORTH STATE ROAD
TOWN OF OSSINING
BRIARCLIFF MANOR, NY

SECTION 90.15, BLOCK 2, LOT 18

roject No:

TLENY-S-17-155

AS NOTED

rawn By:

Approved By:

LB

CHG

DETAIL SHEET

Drawing Number:

C-900


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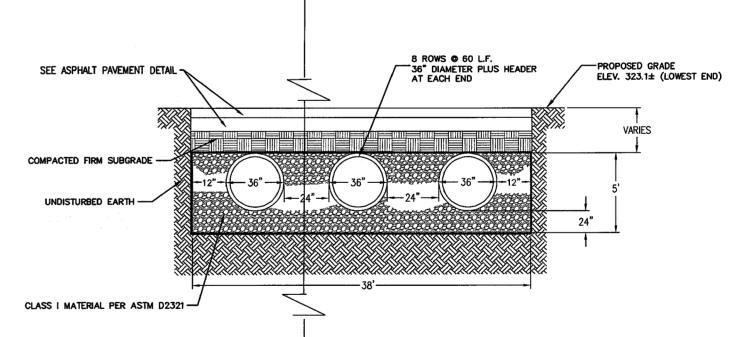
**DUMPSTER ENCLOSURE** 

N.T.S.

> POURED CONCRETE FOOTING

**TYPICAL BLOCK WALL DETAIL** N.T.S.

1. CONTRACTOR SHALL PROVIDE DESIGN CALCULATIONS OF THE SEGMENTAL BLOCK RETAINING WALL AND DRAWINGS SHALL BE SUBMITTED BY THE CONTRACTOR FOR REVIEW, PREPARED, SIGNED AND SEALED BY A LICENSED PROFESSIONAL ENGINEER IN THE STATE OF NEW YORK.

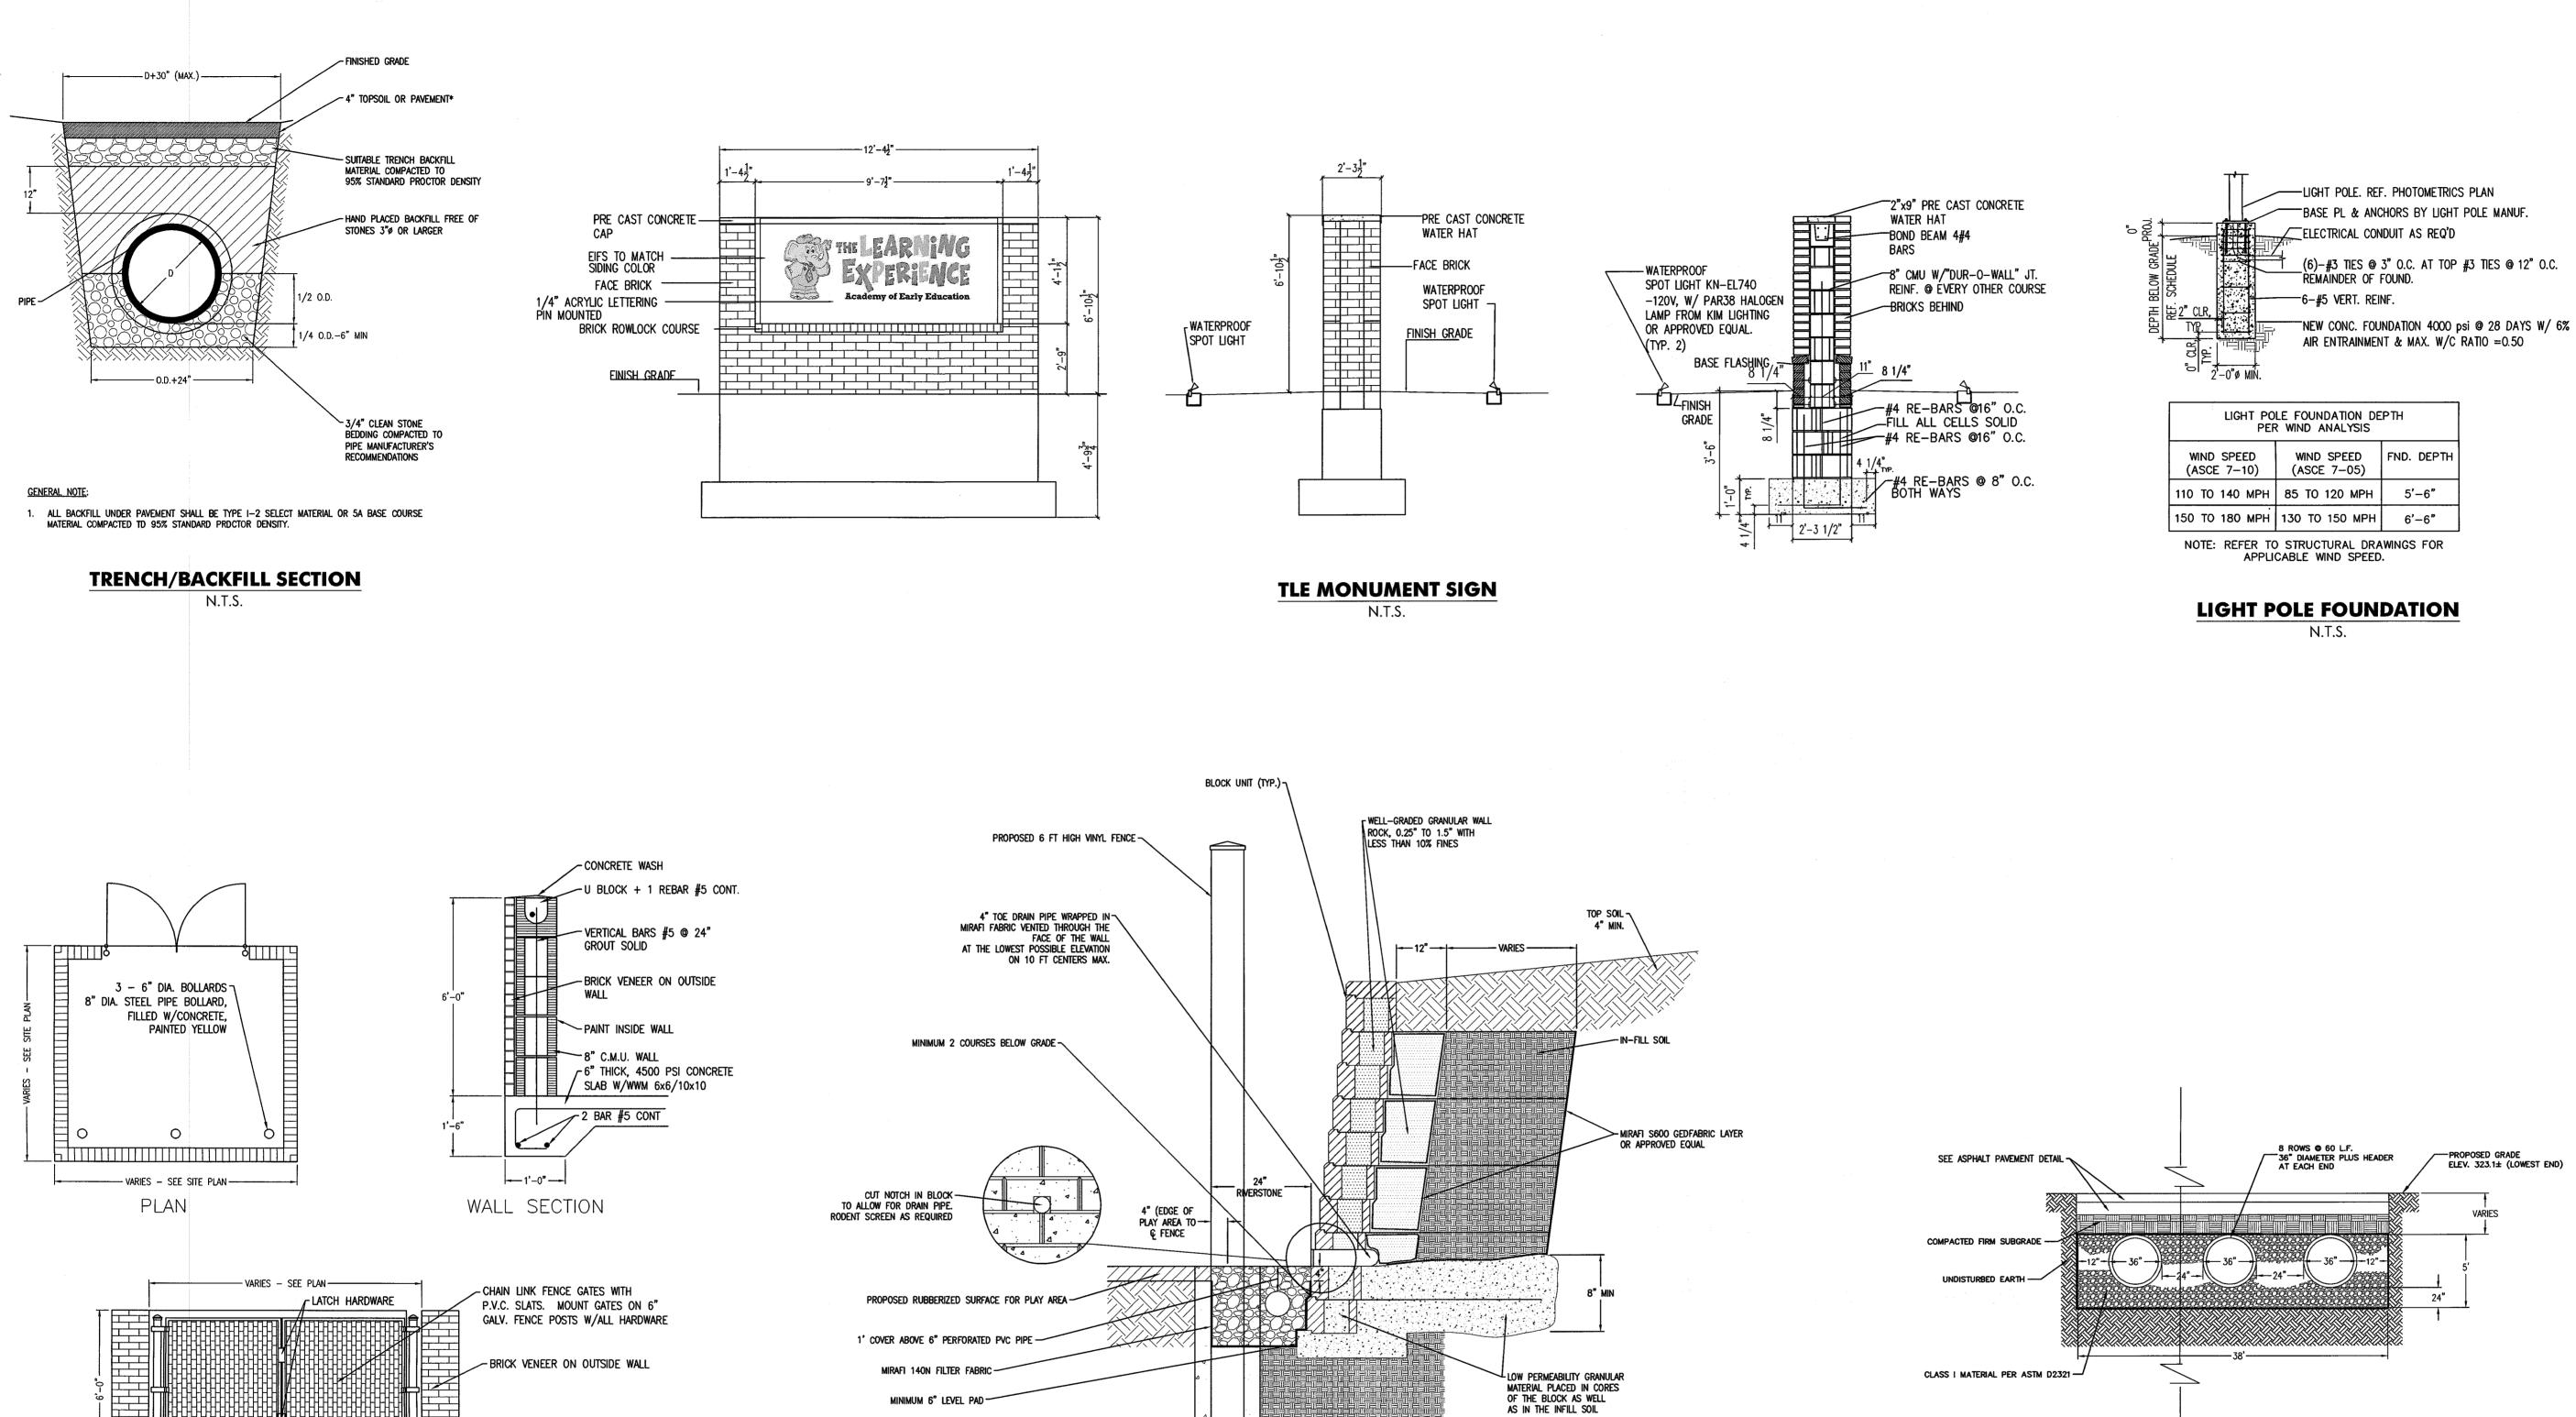

ALL MATERIALS AND METHODS OF CONSTRUCTION SHALL CONFORM TO THE REQUIREMENTS OF TOWN OF OYSTER BAY CONTRACT SPECIFICATIONS, AMENDED JANUARY 2000.

FND. DEPTH

- 2. ALL DETENTION AND RETENTION SYSTEMS SHALL BE INSTALLED IN ACCORDANCE WITH ASTM 2321, "STANDARD PRACTICE FOR UNDERGROUND INSTALLATION OF THERMOPLASTIC PIPE FOR SEWERS AND OTHER GRAVITY FLOW APPLICATIONS", LATEST ADDITION.
- 3. MEASURES SHOULD BE TAKEN TO PREVENT MIGRATION OF NATIVE FINES INTO BACKFILL MATERIAL, WHEN REQUIRED.

### **UNDERGROUND INFILTRATION SYSTEM**

N.T.S.

ARCHITECTS AND ENGINEERS INC. **42 OKNER PARKWAY** 

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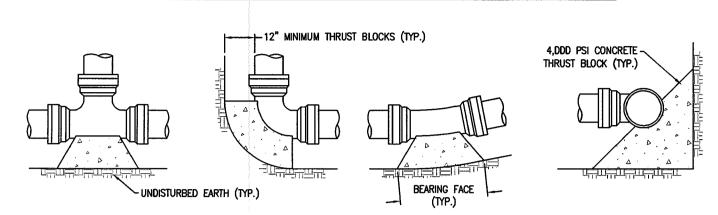
NJ State 8oard Of Architects Authorization No. 161 NJ State Board Of Engineers & Land Surveyors Authorization No. GA-27817 Project: THE LEARNING EXPERIENCE 530 NORTH STATE ROAD


TOWN OF OSSINING BRIARCLIFF MANOR, NY SECTION 90.15, BLOCK 2, LOT 18

AS NOTED TLENY-S-17-155

Drawing Name:

DETAIL SHEET



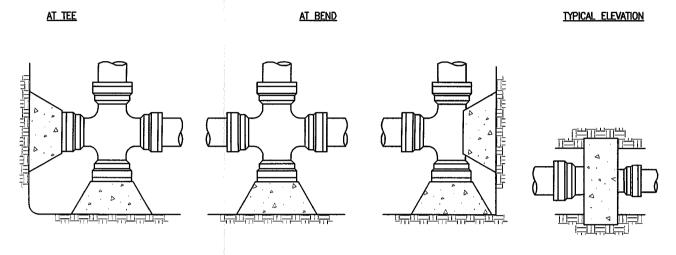

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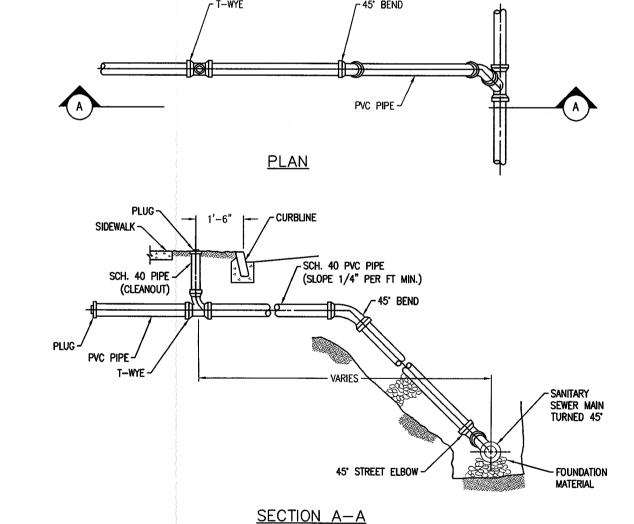
DTES:

- SPECIAL DESIGN IS REQUIRED FOR FITTINGS ON DOMESTIC WATER MAIN PIPE LARGER THAN 12 INCHES.
   THRUST BLOCK IS TO BE POURED AGAINST UNDISTURBED EARTH. WIDTH OF THRUST BLOCK SHOULD BE APPROXIMATELY TWICE HEIGHT.
- 3. THRUST BLOCK IS TO BE INSTALLED AT ALL BENDS, PLUGS, TEES, AND TAPPING SLEEVE AND VALVE CONNECTIONS.

AT TEE. CROSS AND PLUG

- 4. FACTORY CAST OFFSETS ARE TO BE TREATED AS (2) 45 DEGREE BENDS.
- 4. FACIUNT CASI OFFSEIS ARE TO BE TREATED AS (2) 45 DEGREE BENUS.
- 5. FOR REDUCERS, THRUST BLOCK IS TO BE KEYED INTO WALLS AND BOTTOM OF TRENCH.
- 6. MECHANICAL RESTRAINT IS REQUIRED IN ADDITION TO THRUST BLOCK.
- 7. WOOD BLOCKING IS NOT PERMITTED.


## THRUST BLOCK DETAILS




### GENERAL NOTES:

- ALL COUPLINGS, PLUGS, SOIL PIPES & CAPS TO BE STANDARD FOR TYPE OF PIPE USED, INSTALLATION TO BE WATERTIGHT.
- 2. HOUSE CONNECTIONS ARE TO BE 6" P.V.C.
- 3. ALL PLUG THREADS SHALL BE GREASED AT TIME OF INSTALLATION.
- 4. MINIMUM DEPTH OF COVER ON SANITARY SEWER MAINS SHALL BE 5 FEET.
- 5. POLYVINYL CHLORIDE PIPE AND FITTINGS FOR HOUSE LATERALS SHALL CONFORM TO A.S.T.M. D-3034.


## **SANITARY SEWER BUILDING CONNECTION**

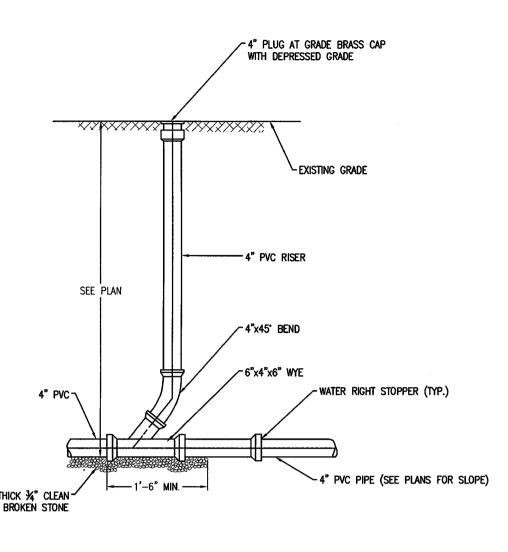


## SANITARY CLEANOUT N.T.S.

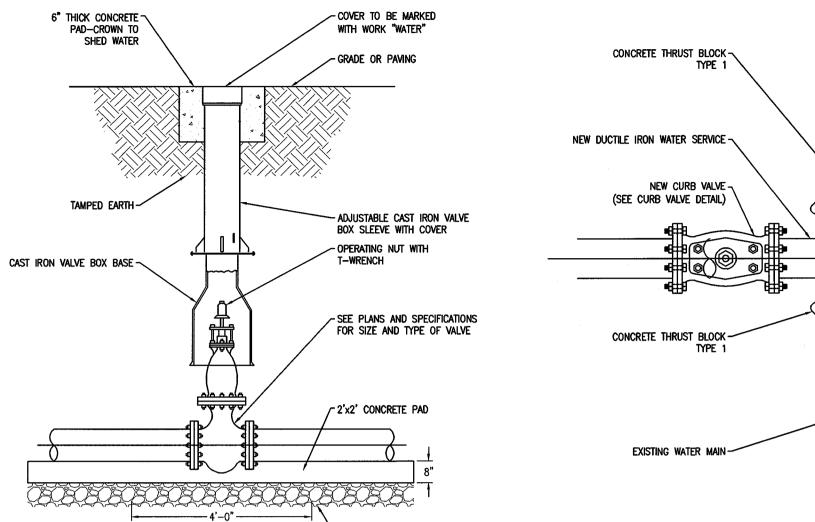


CURB VALVE DETAIL
N.T.S.

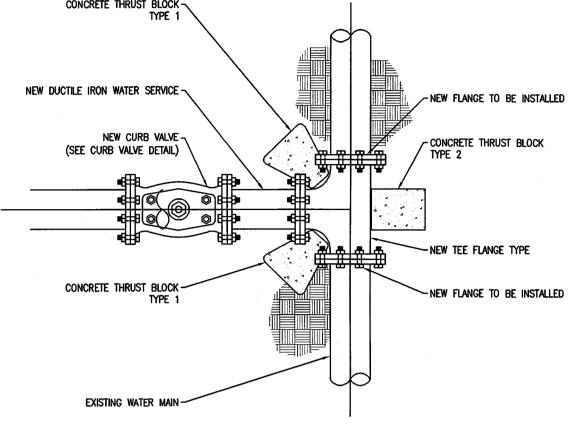


WATER MAIN CONNECTION DETAIL N.T.S.

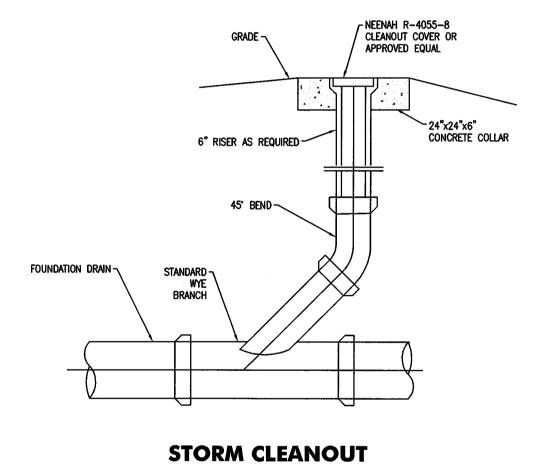

N.T.S.

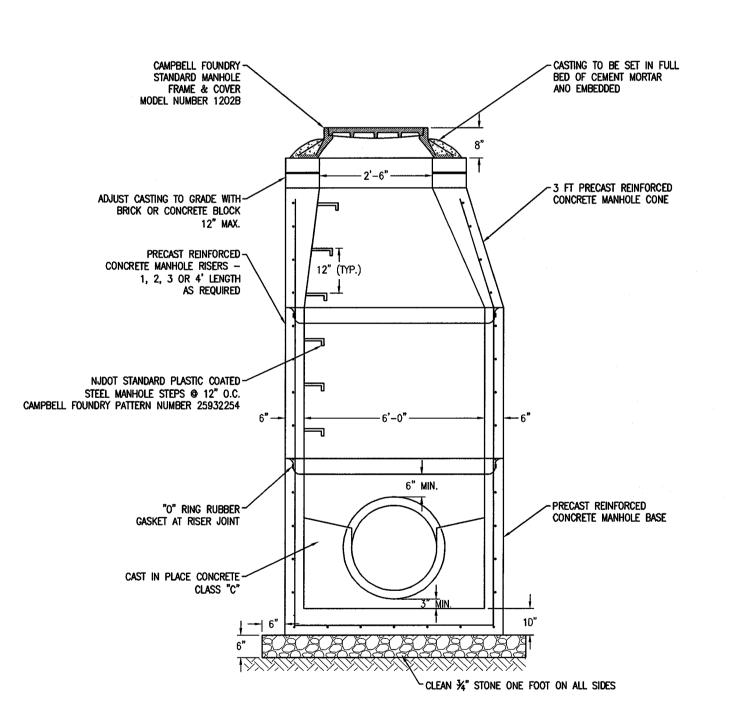

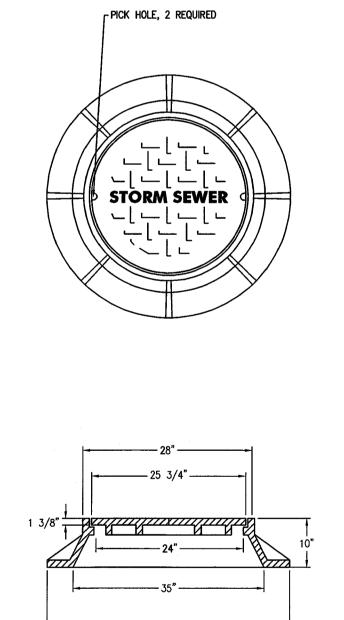

- DIAMETER OF MANHOLE SHALL BE REVIEWED BY THE CONTRACTOR TO DETERMINE A LEGEND OF STANDARD MANHOLE DIMENSIONS WITH RESPECT TO PROPOSED PIPE SIZES, NUMBER AND GEOMETRY. OVER SIZE MANHOLES SHALL BE PROVIDED IF MINIMUM 6" WALL DIMENSION BETWEEN PIPES IS NOT MANUFACTURED.
- 2. MANHOLES SHALL BE STANDARD PRECAST CONCRETE UNITS AND SHALL BE DESIGNED AND CONSTRUCTED BY THE MANUFACTURER TO SUPPORT TRUCK H520 LOADING.

STORM MANHOLE N.T.S.

MANHOLE FRAME AND COVER

N.T.S.

Jarnel Kizel

ARCHITECTS AND ENGINEERS INC.

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 TLENY-S-17-155
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RICHARD AS ARMES
PROFESSIONAL
PRIGHNIER
N.Y. LIC. #073898-1

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